ISSUE **REVISION** DATE INITIAL ISSUE 10/04/10 ADDED UTILITY EASEMENT TO SURVEY 10/19/10 REV. ROBIN ROAD R/W, ADDED V3 10/26/10 REV. TOWER AND COMPOUND LOCATION 10/28/10 REVISED CDs 11/05/10

> E911 ADDRESS WILL BE ISSUED DURING PLAN REVIEW.

PROPERTY OWNER:

CATAWBA COLLEGE

2300 W. INNES ST.

PARCEL ID #:

93690000

SURVEYOR:

SALISBURY, NC 28144

#### A PROJECT FOR:



**CATAWBA COLLEGE** 2300 W. INNES ST. SALISBURY, NC 28144 **ROWAN COUNTY** 

#### DIRECTIONS:

FROM CHARLOTTE, NC: MERGE ONTO I-277 S/US-74 W. FROM W. HILL ST. CONTINUE FOR APPROX. 0.6 MILES. MERGE ONTO I-77 N/US-21 N.VIA EXIT 1C TOWARD STATESVILLE. CONTINUE FOR APPROX. 3.4 MILES. MERGE ONTO I-85 N.VIA EXIT 13A TOWARD GREENSBORO. CONTINUE FOR APPROX. 36.3 MILES. TAKE US-601 N/JAKE ALEXANDER BLVD, EXIT 75. CONTINUE FOR APPROX. 0.2 MILES. TURN LEFT ONTO US-601/JAKE ALEXANDER BLVD S. CONTINUE FOR APPROX. 2.5 MILES. TURN RIGHT ONTO BRENNER AVE. CONTINUE FOR APPROX. 1.6 MILES. TURN RIGHT ONTO STATESVILLE BLVD. CONTINUE FOR APPROX. 0.1 MILES. TURN LEFT ONTO W.INNES ST. CONTINUE FOR APPROX. 0.3 MILES. AND END AT 2300 W. INNES ST., SALISBURY, NC.



VICINITY MAP



#### DRAWING INDEX

## SURVEY

SITE SURVEY (SHEET 1 OF 3) SITE SURVEY (SHEET 2 OF 3) SITE SURVEY (SHEET 3 OF 3)

#### **GENERAL**

GI **GENERAL ABBREVIATIONS** BUILDING CODE APPENDIX B (SHEET 1 OF 2) BUILDING CODE APPENDIX B (SHEET 2 OF 2) G2A

#### CIVIL

CI GENERAL NOTES AND SYMBOLS C2 C3 C3A C4 C5 C6 SITE LAYOUT PLAN SITE GRADING PLAN ACCESS ROAD GRADING PLAN COMPOUND FENCE DETAILS SITE DETAILS TOWER ELEVATION, ANTENNA LAYOUT COAXIAL CABLE SCHEDULE AND NOTES

#### STRUCTURAL

**EQUIPMENT SLAB PLAN AND NOTES** SECTIONS AND DETAILS

#### **ELECTRICAL**

GENERAL ELECTRICAL NOTES AND LEGEND **E2** SERVICES ROUTING PLAN **E**3 SITE GROUNDING PLAN **E4** ONE LINE DIAGRAM E5 E6 **GROUNDING DETAILS** ICE BRIDGE AND GROUNDING DETAILS

E7 E8 **GROUNDING DETAILS** 

UTILITY RACK AND TRENCH DETAILS

#### SITE INFORMATION:

#### APPLICANT:

BERKLEY GROUP LLC 10612-D PROVIDENCE ROAD, PMB 742 CHARLOTTE, NC 28277 BILL GODDARD - PROJECT MANAGER TEL: (704) 643-9101

POWER:

DUKE ENERGY (800) 777-9898

TELCO:

AT&T

(866) 620-6000

#### TOWER INFORMATION:

PROPOSED 175' MONOPOLE PROPOSED RAD CENTER - 175.0' LATITUDE: 35°41'35.46" N LONGITUDE: 80°29'08.21" W GROUND ELEVATION: 658.0'

#### ZONING INFORMATION:

JURISDICTION: CITY OF SALISBURY

CLASSIFICATION: I-C


OCCUPANCY: INSTITUTIONAL CAMPUS


#### **BUILDING INSPECTIONS:**

CITY OF SALISBURY 217 S. MAIN STREET SALISBURY, NC. 28144 (704) 638 - 5242

SANDERS SURVEYING AND MAPPING SERVICES, INC. 510 AVENA ROAD BLACK MOUNTAIN, NC 28711 (828) 669-2777



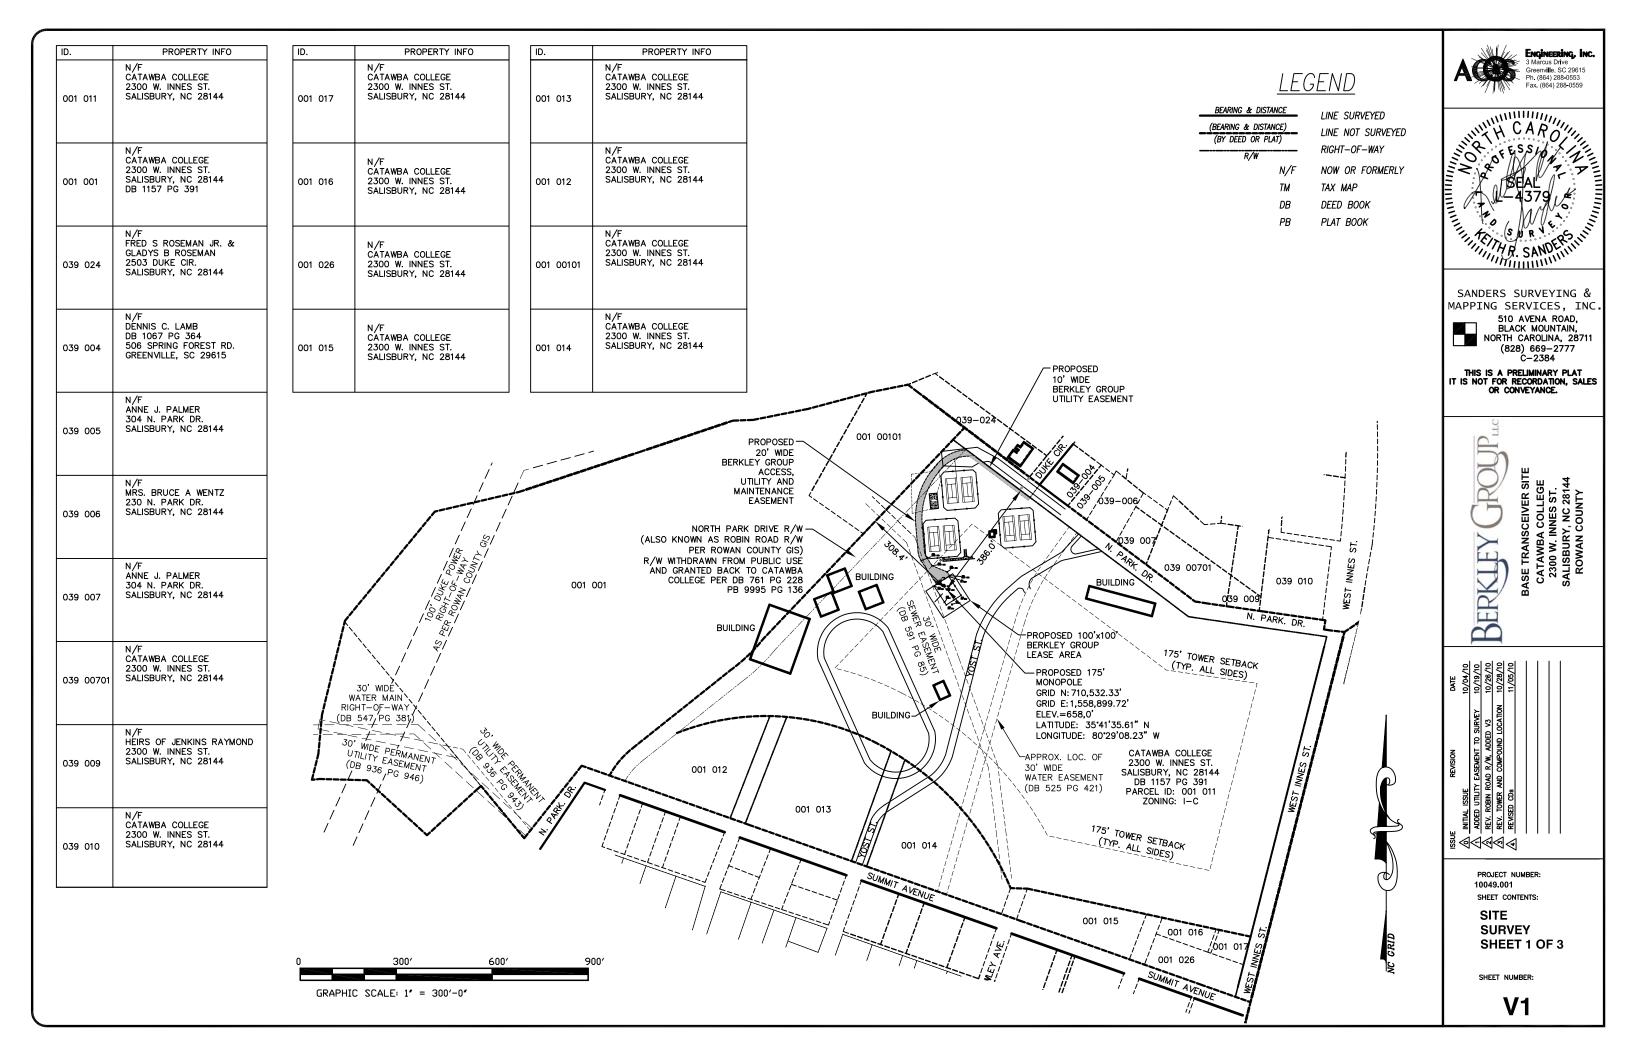

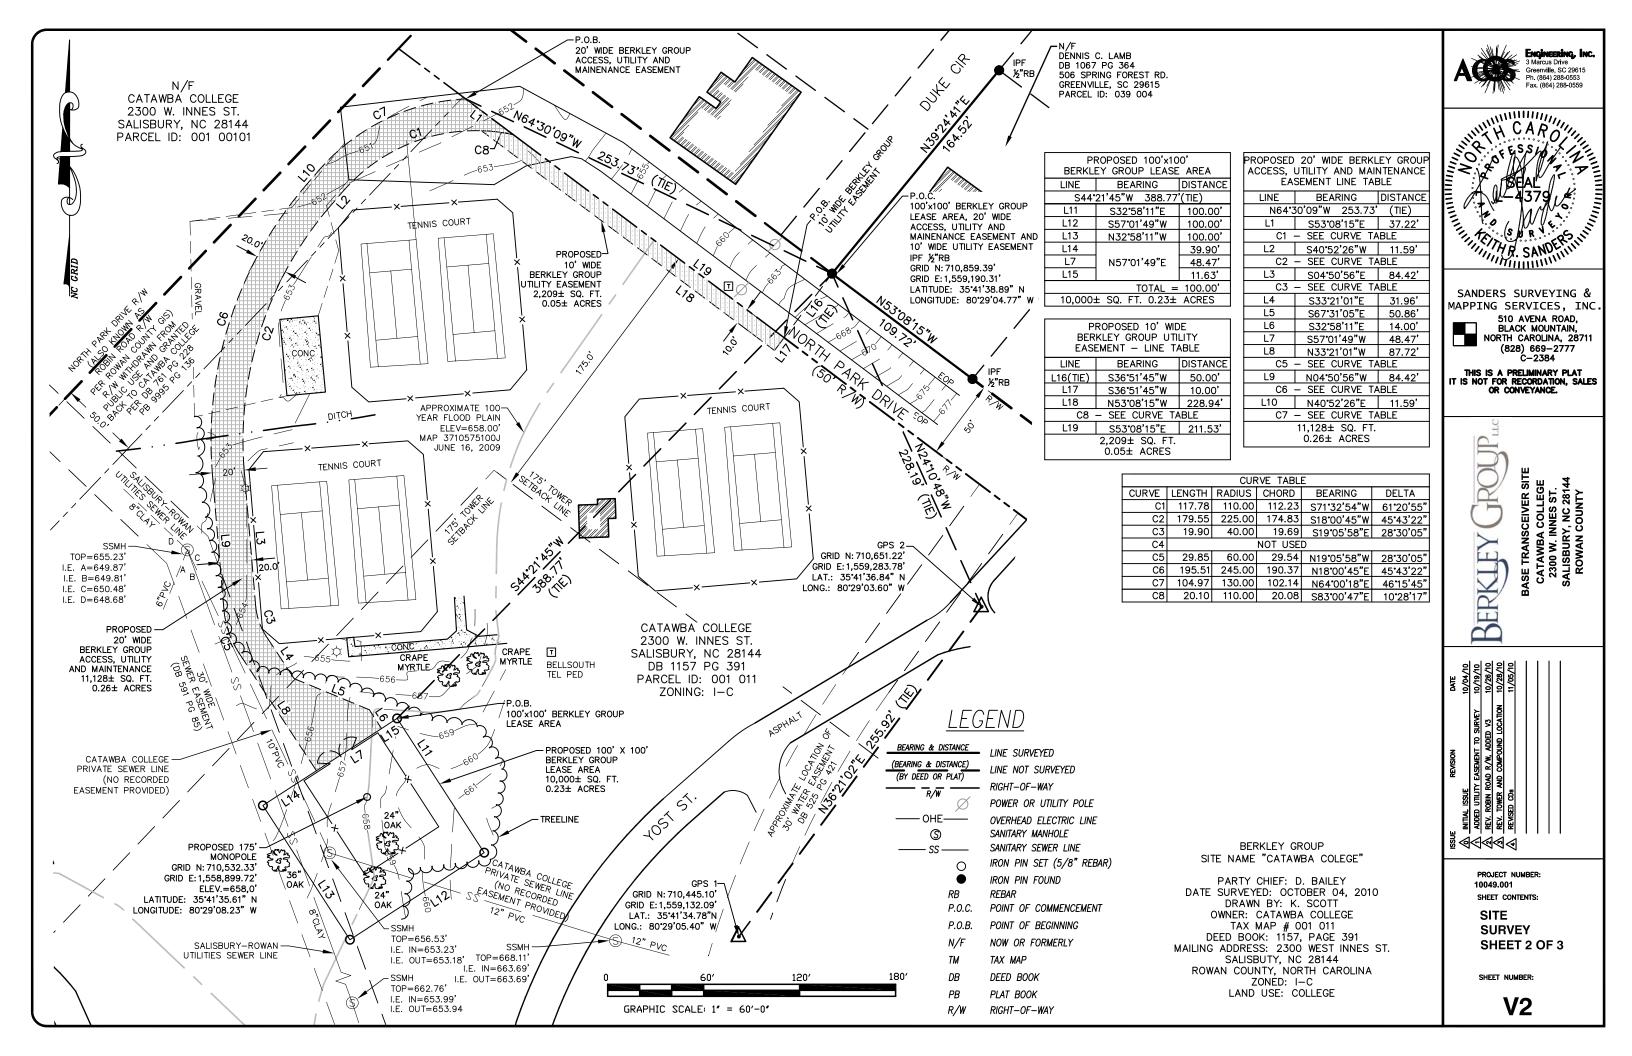

INVESTORS TITLE INSURANCE COMPANY

P.O. DRAWER 2687 CHAPEL HILL, NORTH CAROLINA 2751 5-2687

COMMITMENT NO. 201000151CA2 COMMITMENT DATE: 06/24/2010

SCHEDULE B - SECTION II **EXCEPTIONS** 

ANY POLICY WE ISSUE WILL HAVE THE FOLLOWING EXCEPTIONS UNLESS THEY ARE TAKEN CARE OF TO OUR SATISFACTION.

- TAXES FOR THE YEAR 2010, AND SUBSEQUENT YEARS, NOT YET DUE AND PAYABLE. (NOT A SURVEY ISSUE, NOT PLOTABLE)
- 2. SANITARY SEWER RIGHT-OF-WAY AGREEMENT TO THE CITY OF SALISBURY RECORDED IN BOOK 373 AT PAGE 397. (NOT PLOTABLE, DOES NOT APPEAR TO AFFECT SUBJECT
- 3. SANITARY SEWER RIGHT-OF-WAY AGREEMENT TO THE CITY OF SALISBURY RECORDED IN BOOK 453 AT PAGE 197. (NOT PLOTABLE, DOES NOT APPEAR TO AFFECT SUBJECT PROPERTY)
- 4. RIGHT OF WAY AGREEMENT TO THE CITY OF SALISBURY RECORDED IN BOOK 525 AT PAGE 421. (AFFECTS CATAWBA COLLEGE PROPERTY, AS SHOWN ON PLAT, SHEETS VI AND V2)
- 5. DEED OF EASEMENT TO THE CITY OF SALISBURY RECORDED IN BOOK 547 AT PAGE 381. (AFFECTS CATAWBA COLLEGE PROPERTY, AS SHOWN ON PLAT, SHEET V1)
- 6. GENERAL PERMIT TO SOUTHERN BELL TELEPHONE AND TELEGRAPH COMPANY RECORDED IN BOOK 555 AT PAGE 882. (MAY OR MAY NOT AFFECT SUBJECT PROPERTY, DOCUMENT NOT LEGIBLE)
- 7. DEED OF EASEMENT TO THE CITY OF SALISBURY RECORDED IN BOOK 591 AT PAGE 85. (AFFECTS SUBJECT PROPERTY, AS SHOWN ON PLAT, SHEETS V1 AND V2)
- 8. RIGHT-OF-WAY EASEMENT TO SOUTHERN BELL TELEPHONE AND TELEGRAPH COMPANY RECORDED IN BOOK 614 AT PAGE 307. (NOT LEGIBLE, DOES NOT APPEAR TO AFFECT SUBJECT PROPERTY)
- 9. EASEMENT TO DUKE POWER COMPANY RECORDED IN BOOK 615 AT PAGE 690. (BLANKET IN NATURE)
- 10. ROAD MAINTENANCE AGREEMENT RECORDED IN BOOK 648 AT PAGE 630. (NOT PLOTABLE, DOES NOT APPEAR TO AFFECT SUBJECT PROPERTY)
- 11, DECLARATION OF WITHDRAWAL OF STREET FROM PUBLIC USE RECORDED IN BOOK 761 AT PAGE 228. (AFFECTS SUBJECT PROPERTY, AS SHOWN ON PLAT, SHEETS V1 AND
- 12. DEED OF EASEMENT TO THE CITY OF SALISBURY RECORDED IN BOOK 936 AT PAGE 943. (AFFECT CATAWBA COLLEGE PROPERTY, AS SHOWN ON PLAT, SHEET V1)
- 13. DEED OF EASEMENT TO THE CITY OF SALISBURY RECORDED IN BOOK 936 AT PAGE 946. (AFFECT CATAWBA COLLEGE PROPERTY, AS SHOWN ON PLAT, SHEET V1)
- 14. EASEMENT AND MEMORANDUM OF AGREEMENT TO TIME WARNER ENTERTAINMENT -ADVANCE/NEWHOUSE PARTNERSHIP RECORDED IN BOOK 1098 AT PAGE 401. (BLANKET IN NATURE)
- 15. SUBORDINATION, NON-DISTURBANCE AND ATTORNMENT AGREEMENT RECORDED IN BOOK 1157 AT PAGE 813. (NOT A SURVEY ISSUE)
- 17. DEED OF TRUST TO RBC BANK (USA), RECORDED IN BOOK 1157 AT PAGE 391, TO SECURE \$58, 000, 000. 00. (NOT A SURVEY ISSUE)
- 18. DEED OF TRUST TO SECRETARY OF HOUSING AND URBAN DEVELOPMENT, RECORDED IN BOOK M-398 AT PAGE 476, TO SECURE \$543,000.00. (NOT A SURVEY ISSUE)
- 19. UCC FINANCING STATEMENT TO RBC BANK (USA) RECORDED IN BOOK 1157 AT PAGE 392. (NOT A SURVEY ISSUE)
- 20. SUBJECT TO THE FEE SIMPLE INTEREST OF CATAWBA COLLEGE, A NORTH CAROLINA CORPORATION. (NOT A SURVEY ISSUE)
- 21. LOSS OR DAMAGE RESULTING FROM FAILURE TO COMPLY WITH THE TERMS AND PROVISIONS OF LEASE SET FORTH UNDER SCHEDULE A HEREOF, CREATING THE LEASEHOLD ESTATE INSURED. (NOT A SURVEY ISSUE)
- 22. ANY ENCROACHMENT, ENCUMBRANCE, VIOLATION, VARIATION, OR ADVERSE CIRCUMSTANCE AFFECTING THE TITLE THAT WOULD BE DISCLOSED BY AN ACCURATE AND COMPLETE LAND SURVEY OF THE LAND. THE TERM "ENCROACHMENT" INCLUDES ENCROACHMENTS OF EXISTING IMPROVEMENTS LOCATED ON THE LAND ONTO ADJOINING LAND, AND ENCROACHMENTS ONTO THE LAND OF EXISTING IMPROVEMENTS LOCATED ON ADJOINING LAND. PARAGRAPH 2 (C) OF THE COVERED RISKS IS HEREBY DELETED. NOTE: UPON RECEIPT OF SATISFACTORY PLAT OF SURVEY AND SURVEYOR'S REPORT, THIS EXCEPTION WILL BE ELIMINATED OR AMENDED IN ACCORDANCE WITH THE FACTS DISCLOSED THEREBY.

- 1. BEARINGS ARE NORTH CAROLINA GRID AND DISTANCES ARE GROUND UNLESS OTHERWISE SHOWN OR NOTED. COORDINATES ARE ON NORTH CAROLINA GRID (NAD 83) AND THE VERTICAL DATUM IS (NAVD 88).
- GRID COORDINATES SHOWN WERE OBTAINED FROM USE OF GPS OBSERVATION, USING A TOPCON HIPER+ SURVEY GRADE RECIEVER (DUAL FREQUENCY). USING "NGS OPUS SOLUTION".
- ALL IPS ARE 5/8" IRON REBAR UNLESS OTHERWISE NOTED.
  THE RATIO OF PRECISION OF THE UNBALANCED TRAVERSE MEETS OR EXCEEDS 1: 10,000.
- THE FEATURE SYMBOL LOCATIONS ARE TO THE CENTER OF THE SYMBOL AND MAY BE ENLARGED FOR CLARITY.
- THE UNDERGROUND UTILITIES SHOWN HEREON HAVE BEEN LOCATED FROM FILED SURVEY INFORMATION AND EXISTING DRAWINGS MADE AVAILABLE AND PROVIDED TO THE UNDERSIGNED SURVEYOR. THE SURVEYOR MAKES NO GUARANTEE THAT THE UNDERGROUND UTILITIES SHOWN COMPRISE ALL SUCH UTILITIES IN THE AREA, EITHER IN SERVICE OR ABANDONED. THE SURVEYOR FURTHER DOES NOT WARRANT THE UNDERGROUND UTILITIES SHOWN ARE IN THE EXACT LOCATION INDICATED. ALTHOUGH THE UNDERSIGNED DOES STATE THAT THEY ARE LOCATED AS ACCURATELY AS POSSIBLE FROM THE INFORMATION AVAILABLE AND PROVIDED. THE SURVEYOR HAS NOT PHYSICALLY LOCATED THE UNDERGROUND UTILITIES.
- THE UNDERSIGNED, DOES NOT WARRANT THE EXISTENCE OR NONEXISTENCE OF ANY HAZARDOUS WASTE ON THE SURVEY SITE.

  8. THE UNDERSIGNED DOES NOT WARRANT THE EXISTENCE OR
- NONEXISTENCE OF ANY JURISDICTIONAL WETLANDS ON THE SURVEY SITE OTHER THAN SHOWN, IF ANY. WETLANDS SHOWN ARE SUBJECT TO FINAL APPROVAL BY THE U.S. CORPS. OF ENGINEERS.
- THIS PLAT WAS PREPARED AS A PROFESSIONAL SERVICE FOR THE EXCLUSIVE USE OF THE PERSON, PERSONS, OR ENTITY NAMED WITHIN THE HEREON STATEMENT AND/OR TITLE. SAID STATEMENT DOES NOT EXTEND TO ANY UNNAMED PERSON, PERSONS OR ENTITY WITHOUT THE EXPRESSED PERMISSION OF AC&S, NAMING SAID PERSON, PERSONS, OR ENTITY.
- 10. AREA COMPUTED BY DMD METHOD.
- 11. THE SURVEY IS OF AN EXISTING PARCEL OR PARCELS OF LAND AND DOES NOT CREATE A NEW STREET OR CHANGE AN EXISTING

TO BERKLEY GROUP AND INVESTORS TITLE INSURANCE COMPANY:

THIS IS TO CERTIFY THAT THIS MAP OR PLAT AND THE SURVEY ON WHICH IT IS BASED WERE MADE IN ACCORDANCE WITH THE "MINIMUM STANDARD DETAIL REQUIREMENTS FOR ALTA / ACSM LAND TITLE SURVEYS JOINTLY ESTABLISHED AND ADOPTED BY ALTA AND NSPS IN 2005, AND INCLUDES ITEMS 1-18 OF TABLE A THEREOF. PURSUANT TO THE ACCURACY STANDARDS AS ADOPTED BY ALTA AND NSPS AND IN EFFECT ON THE DATE OF THIS CERTIFICATION... UNDERSIGNED FURTHER CERTIFIES THAT IN MY PROFESSIONAL OPINION, AS A LAND SURVEYOR REGISTERED IN THE STATE OF NORTH CAROLINA, THE RELATIVE POSITIONAL ACCURACY OF THIS SURVEY DOES NOT EXCEED THAT WHICH IS SPECIFIED THEREIN.

DATE: 10/28/10

KEITH R. SANDERS L-4379

PROPOSED 100'X100' BERKLEY GROUP LEASE AREA LEGAL DESCRIPTION PER SURVEYOR

BEING A PORTION OF THAT CERTAIN PIECE, PARCEL OR TRACT OF LAND SITUATED, LYING AND BEING IN SALISBURY, ROWAN COUNTY, NORTH CAROLINA, NOW OR FORMERLY OWNED BY CATAWBA COLLEGE, AS DESCRIBED IN DEED BOOK 1070, PAGE 434, AS RECORDED IN ROWAN COUNTY REGISTRY, CONTAINING 0.23 ACRES AS SHOWN ON PLAT ENTITLED "SITE SURVEY, SHEET 2 OF 3", PREPARED BY AC&S ENGINEERING, INC, DATED 10/04/10, LAST REVISED 10/26/10.

COMMENCING AT 1/2" REBAR FOUND, LOCATED ON THE INTERSECTION OF SOUTHEASTERN RIGHT-OF-WAY OF DUKE CIRCLE AND NORTHEASTERN RIGHT-OF-WAY OF NORTH PARK DRIVE (50' R/W), ALSO BEING WESTERN MOST CORNER OF PROPERTY NOW OR FORMERLY OWNED BY DENNIS C. LAMB. AS DESCRIBED IN DEED BOOK 1067, PAGE 364, AS RECORDED IN ROWAN. COUNTY REGISTRY, HAVING A NORTH CAROLINA STATE PLANE COORDINATES (NAD 83) N: 710.859.39, E: 1.559.190.31, THENCE ALONG A TIE LINE S 44'21'45" W. A DISTANCE OF 388.77 FEET TO A 5/8" REBAR SET ON THE NORTHERN MOST CORNER OF 100'X100' BERKLEY GROUP LEASE AREA. THIS POINT BEING THE POINT OF BEGINNING.

THENCE S 32°58'11" E, A DISTANCE OF 100.00 FEET TO A 5/8" REBAR SET; THENCE S 57'01'49" W, A DISTANCE OF 100.00 FEET TO A 5/8" REBAR SET; THENCE N 32°58'11" W. A DISTANCE OF 100.00 FEET TO A 5/8" REBAR SET: THENCE N 57°01'49" E, A DISTANCE OF 100.00 FEET TO THE POINT OF BEGINNING. THIS LEASE AREA TO CONTAIN 10,000 SQ. FT. OR 0.23 ACRES MORE OR LESS.

PROPOSED 20' WIDE BERKLEY GROUP ACCESS, UTILITY AND MAINTENANCE EASEMENT LEGAL DESCRIPTION PER SURVEYOR

BEING A PORTION OF THAT CERTAIN PIECE, PARCEL OR TRACT OF LAND SITUATED, LYING AND BEING IN SALISBURY, ROWAN COUNTY, NORTH CAROLINA, NOW OR FORMERLY OWNED BY CATAWBA COLLEGE, AS DESCRIBED IN DEED BOOK 1070, PAGE 434, AS RECORDED IN ROWAN COUNTY REGISTRY, CONTAINING 0.26 ACRES AS SHOWN ON PLAT ENTITLED "SITE SURVEY, SHEET 2 OF 3", PREPARED BY AC&S ENGINEERING, INC, DATED 10/04/10, LAST REVISED 10/26/10.

COMMENCING AT 1/2" REBAR FOUND. LOCATED ON THE INTERSECTION OF SOUTHEASTERN RIGHT-OF-WAY OF DUKE CIRCLE AND NORTHEASTERN RIGHT-OF-WAY OF NORTH PARK DRIVE (50' R/W). ALSO BEING WESTERN MOST CORNER OF PROPERTY NOW OR FORMERLY OWNED BY DENNIS C. LAMB, AS DESCRIBED IN DEED BOOK 1067, PAGE 364, AS RECORDED IN ROWAN COUNTY REGISTRY, HAVING A NORTH CAROLINA STATE PLANE COORDINATES (NAD 83) N: 710,859.39, E: 1,559,190.31. THENCE ALONG A TIE LINE N 64'30'09" W, A DISTANCE OF 253.73 FEET TO A POINT LOCATED ON THE SOUTHWESTERN RIGHT-OF-WAY OF NORTH PARK DRIVE AND ON NORTHEASTERN BOUNDARY OF SAID ROWAN COLLEGE PROPERTY. THIS POINT BEING THE POINT OF REGINNING

THENCE ALONG SAID SOUTHWESTERN RIGHT-OF-WAY OF NORTH PARK DRIVE S 53'08'15" E. A DISTANCE OF 37.22 FEET TO

THENCE LEAVING SAID NORTH PARK DRIVE RIGHT-OF-WAY AND RUNNING ALONG A CURVE TO THE LEFT HAVING A RADIUS OF 110.0 FEET, A CURVE LENGTH OF 117.78 FEET AND A CHORD BEARING AND DISTANCE OF S 71'32'54" W, 112.23 FEET TO A

THENCE S 40'52'26" W, A DISTANCE OF 11.59 FEET TO A POINT;
THENCE ALONG A CURVE TO THE LEFT HAVING A RADIUS OF 225.00 FEET, A CURVE LENGTH OF 179.55 FEET, AND A CHORD BEARING AND DISTANCE OF S 18'00'45" W, A DISTANCE OF 174.83 FEET TO A POINT; THENCE S 04°50'56" E. A DISTANCE OF 84.42 FEET TO A POINT:

THENCE ALONG A CURVE TO THE LEFT HAVING A RADIUS OF 40.00 FEET, A CURVE LENGTH OF 19.90 FEET AND A CHORD BEARING AND DISTANCE OF S 19°05'58" E. 19.69 FEET TO A POINT:

THENCE S 33°21'01" E, A DISTANCE OF 31.96 FEET TO A POINT;

THENCE S 67°31'05" E, A DISTANCE OF 50.86 FEET TO A POINT;

THENCE S 32'58'11" E, A DISTANCE OF 14.00 FEET TO A POINT ON NORTHERN BOUNDARY OF BERKLEY GROUP 100'X100'

THENCE ALONG THAT NORTHERN BOUNDARY OF SAID LEASE AREA S 57'01'49" W, A DISTANCE OF 48.47 FEET TO A POINT; THENCE LEAVING SAID LEASE AREA N 33°21'01" W, A DISTANCE OF 87.72 FEET TO A POINT;

THENCE ALONG A CURVE TO THE RIGHT HAVING A RADIUS OF 60.00 FEET, A CURVE LENGTH OF 29.85 FEET AND A CHORD BEARING AND DISTANCE OF N 19°05'58" W, 29.54 FEET TO A POINT;

THENCE N 04°50'56" W, A DISTANCE OF 84.42 FEET TO A POINT;

THENCE ALONG A CURVE TO THE RIGHT HAVING A RADIUS OF 245.00 FEET, A CURVE LENGTH OF 195.51 FEET AND A CHORD BEARING AND DISTANCE OF N 18'00'45" E, 190.37 FEET TO A POINT;

THENCE N 40°52'26" E, A DISTANCE OF 11.59 FEET TO A POINT; THENCE ALONG A CURVE TO THE RIGHT HAVING A RADIUS OF 130.00 FEET, A CURVE LENGTH OF 104.97 FEET AND A CHORD

BEARING AND DISTANCE OF N 64'00'18" E, 102.14 FEET TO THE POINT OF BEGINNING. THIS EASEMENT TO CONTAIN 11,128 SQ. FT OR 0.26 ACRES MORE OR LESS.

### PROPOSED 10' WIDE BERKLEY GROUP UTILITY EASEMENT LEGAL DESCRIPTION PER SURVEYOR

BEING A PORTION OF THAT CERTAIN PIECE, PARCEL OR TRACT OF LAND SITUATED, LYING AND BEING IN SALISBURY, ROWAN COUNTY, NORTH CAROLINA, NOW OR FORMERLY OWNED BY CATAWBA COLLEGE, AS DESCRIBED IN DEED BOOK 1070, PAGE 434, AS RECORDED IN ROWAN COUNTY REGISTRY, CONTAINING 0.05 ACRES AS SHOWN ON PLAT ENTITLED "SITE SURVEY, SHEET 2 OF 3", PREPARED BY AC&S ENGINEERING, INC, DATED 10/04/10, LAST REVISED 10/26/10.


COMMENCING AT 1/2" REBAR FOUND, LOCATED ON THE INTERSECTION OF SOUTHEASTERN RIGHT-OF-WAY OF DUKE CIRCLE AND NORTHEASTERN RIGHT-OF-WAY OF NORTH PARK DRIVE (50' R/W), ALSO BEING WESTERN MOST CORNER OF PROPERTY NOW OR FORMERLY OWNED BY DENNIS C. LAMB, AS DESCRIBED IN DEED BOOK 1067, PAGE 364, AS RECORDED IN ROWAN COUNTY REGISTRY, HAVING A NORTH CAROLINA STATE PLANE COORDINATES (NAD 83) N: 710.859.39. E: 1.559.190.31. THENCE ALONG A TIE LINE S 36'51'45" W, A DISTANCE OF 50.00 FEET TO POINT ON THE SOUTHWESTERN RIGHT-OF-WAY OF NORTH PARK DRIVE. THIS POINT BEING THE POINT OF BEGINNING.

THENCE LEAVING SAID RIGHT-OF-WAY S 36°51'45" W, A DISTANCE OF 10.00 FEET TO A POINT; THENCE N 53'08'15" W, A DISTANCE OF 228.94 FEET TO A POINT ON THE 20' WIDE BERKLEY GROUP ACCESS, UTILITY AND

MAINTENANCE FASEMENT THENCE ALONG SAID EASEMENT AND ALONG A CURVE TO THE RIGHT HAVING A RADIUS OF 110 FEET, A CURVE LENGTH OF 20.10 FEET AND A CHORD BEARING AND DISTANCE OF S 83'00'47" E, 20.08 FEET TO A POINT ON THE SOUTHWESTERN RIGHT-OF-WAY OF NORTH PARK DRIVE;

THENCE ALONG SAID RIGHT-OF-WAY S 53'08'15" E, A DISTANCE OF 211.53 FEET TO THE POINT OF BEGINNING. THIS EASEMENT TO CONTAIN 2,209 SQ. FT OR 0.05 ACRES MORE OR LESS.



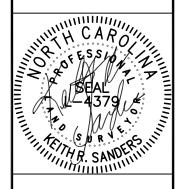

SANDERS SURVEYING & MAPPING SERVICES, INC.



510 AVENA ROAD. BLACK MOUNTAIN. NORTH CAROLINA, 28711 (828) 669-2777 Ć-2384


THIS IS A PRELIMINARY PLAT IT IS NOT FOR RECORDATION, SALES OR CONVEYANCE.



PROJECT NUMBER: 10049.001 SHEET CONTENTS:

SITE **SURVEY** SHEET 3 OF 3

SHEET NUMBER:

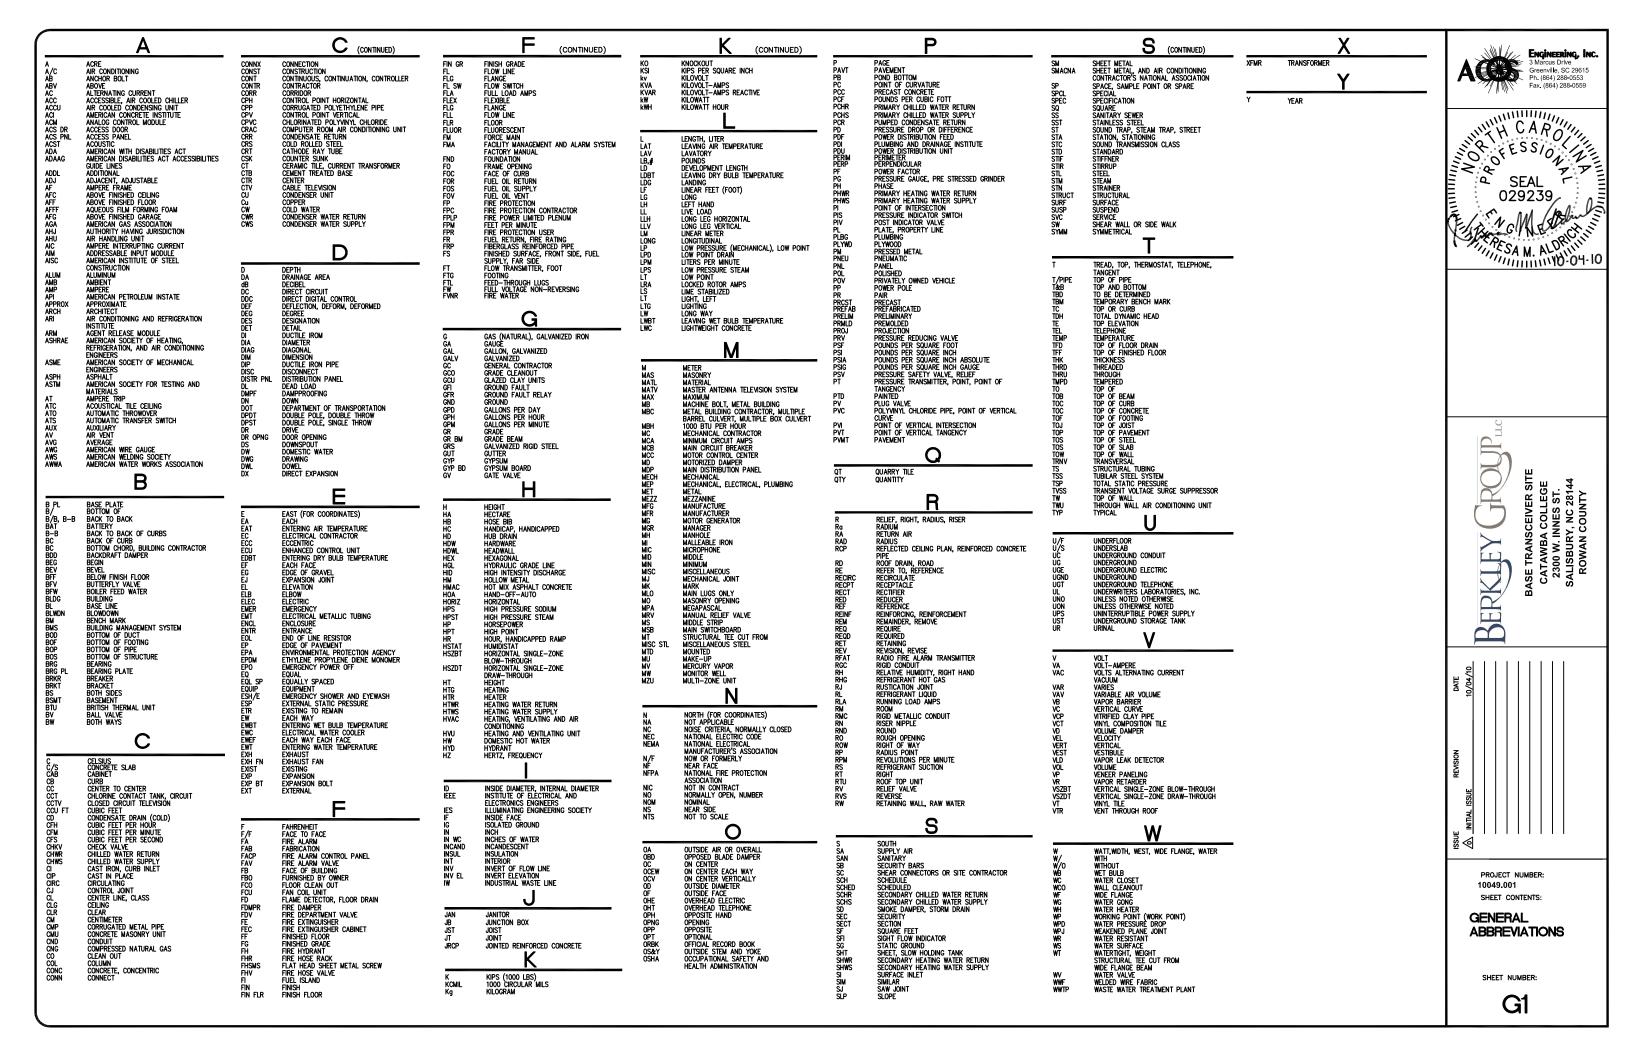


CIVIL S	SYMBOLS	
EXISTING	ITEM	NEW
Ø	POWER POLE WITH LIGHT LIGHT POLE POWER POLE GUY ANCHOR OVERHEAD ELECTRIC	-ф- — ОНЕ —
E	ELECTRIC MANHOLE COMMUNICATIONS MANHOLE UTILITY BOX	
	BUILDING POST SIGN GAS METER GAS VALVE GAS LINE	
	SANITARY SEWER LINE & MANHOLE SANITARY SEWER CLEAN OUT	
\( \sqrt{\sq}\}}}\sqrt{\sq}}}\sqrt{\sq}}}}}}}}}\sqrt{\sqrt{\sqrt{\sqrt{\sqrt{\sqrt{\sqrt{\sqrt{\sqrt{\sqrt{\sqrt{\sqrt{\sqrt{\sqrt{\sqrt{\sqrt{\sqrt{\sqrt{\sqrt{\sq}}}}}}}}\sqrt{\sqrt{\sqrt{\sqrt{\sq}}}}}}}}\sqrt{\sqrt{\sqrt{\sq}\sqrt{\sqrt{\sqrt{\sqrt{\sqrt{\sq}}}}}\sqit{\sqrt{\sq}\sq}}}}\sqrt{\sqrt{\sq}\sq}}}}\sqrt{\sqrt{\sq}}}}}}}}}}}}}}}}}}}}}}}}}}}}}}}	FIRE HYDRANT POST INDICATOR VALVE WATER LINE & VALVE WATER METER	-∳ <u>-6"</u> w <del></del> (W)
— SD —	FIRE WATER LINE ABANDONED UTILITY CULVERT WITH HEADWALLS STORM DRAIN STORM DRAIN HEADWALL	24" \\ \( \frac{24"}{24"} \\ \( \frac{1}{24"} \\ \(
□ ◎  →	AREA INLET STORM DRAIN MANHOLE  © DRAINAGE DITCH FLOW DIRECTION CONTOURS	<b>B (b) (c) (c) (c) (d) (d) (d) (e) (e) (e) (e) (f) </b>
X 712.13	SPOT ELEV.	713.1
 x	SIDEWALK/GRAVEL CONCRETE PAVING ASPHALT SURFACE COURSE CURB & GUTTER EDGE OF PAVEMENT CHAIN LINK FENCE	x
	ITEM TO BE REMOVED	
	PARKING STRIPING / HC PARKING	<b>6</b>
	HC RAMP	•
~~~	BOLLARD  IRON PIN SET  WOODS  SILT FENCE	• • • • • • • • • •

#### **GENERAL NOTES**

- 1. THE FACILITY IS AN UNOCCUPIED WIRELESS FACILITY.
- PLANS ARE NOT TO BE SCALED AND ARE INTENDED TO BE A
  DIAGRAMMATIC OUTLINE ONLY, UNLESS NOTED OTHERWISE. THE
  WORK WILL INCLUDE FURNISHING MATERIALS, EQUIPMENT,
  APPURTENANCES, AND LABOR NECESSARY TO COMPLETE ALL
  INSTALLATIONS AS INDICATED ON THE DRAWINGS.
- 3. PRIOR TO THE SUBMISSION OF BIDS, THE CONTRACTORS WILL VISIT THE JOB SITE AND BE RESPONSIBLE FOR ALL CONTRACT DOCUMENTS, FIELD CONDITIONS AND DIMENSIONS, AND CONFIRMING THAT THE WORK MAY BE ACCOMPLISHED AS SHOWN PRIOR TO PROCEEDING WITH CONSTRUCTION. ANY DISCREPANCIES ARE TO BE BROUGHT TO THE ATTENTION OF THE PROJECT ENGINEER AND ARCHITECT/ENGINEER PRIOR TO PROCEEDING WITH THE WORK.
- WRITTEN AUTHORIZATION IS REQUIRED BEFORE STARTING WORK ON ANY ITEM NOT CLEARLY DEFINED OR IDENTIFIED BY THE CONTRACT DOCUMENTS.
- CONTACT LOCAL DIGGERS HOTLINE 48 HOURS PRIOR TO PROCEEDING WITH ANY EXCAVATION, SITE WORK OR CONSTRUCTION.
- INSTALL ALL EQUIPMENT AND MATERIALS IN ACCORDANCE WITH MANUFACTURER'S RECOMMENDATIONS UNLESS SPECIFICALLY INDICATED OTHERWISE OR WHERE LOCAL CODES OR REGULATIONS TAKE PRECEDENCE.
- 7. ALL WORK PERFORMED AND MATERIALS INSTALLED WILL BE IN STRICT ACCORDANCE WITH ALL APPLICABLE CODES, REGULATIONS, AND ORDINANCES. THE CONTRACTOR WILL GIVE ALL NOTICES AND COMPLY WITH ALL LAWS, ORDINANCES, RULES, REGULATIONS, AND LAWFUL ORDERS OF ANY PUBLIC AUTHORITY REGARDING THE PERFORMANCE OF THE WORK. MECHANICAL AND ELECTRICAL SYSTEMS SHALL BE INSTALLED IN ACCORDANCE WITH ALL APPLICABLE MUNICIPAL AND UTILITY COMPANY SPECIFICATIONS, AND LOCAL AND STATE JURISDICTIONAL CODES, ORDINANCES. AND APPLICABLE REGULATIONS.
- B. THE GENERAL CONTRACTOR WILL SUPERVISE AND DIRECT THE WORK, USING THE BEST SKILLS AND ATTENTION. THE CONTRACTOR WILL BE SOLELY RESPONSIBLE FOR ALL CONSTRUCTION MEANS, METHODS, TECHNIQUES, SEQUENCES AND PROCEDURES, AND FOR COORDINATING ALL PORTIONS OF THE WORK UNDER THE CONTRACT INCLUDING CONTACT AND COORDINATION WITH THE PROJECT ENGINEER AND WITH THE LANDLORD'S AUTHORIZED REPRESENTATIVE.
- 9. DETAILS ARE INTENDED TO SHOW END RESULT OF DESIGN.
  MINOR MODIFICATIONS MAY BE REQUIRED TO SUIT JOB
  DIMENSIONS OR CONDITIONS, AND SUCH MODIFICATIONS WILL BE
  INCLUDED AS PART OF THE WORK.
- O. REPRESENTATIONS OF TRUE NORTH, OTHER THAN THOSE FOUND ON THE PLAT OF THE SURVEY DRAWING, WILL NOT BE USED TO IDENTIFY OR ESTABLISH THE BEARING OF TRUE NORTH AT THE SITE. THE CONTRACTOR WILL RELY SOLELY ON THE PLAT OF SURVEY DRAWING AND ANY SURVEYOR'S MARKINGS AT THE SITE FOR THE ESTABLISHMENT OF TRUE NORTH, AND WILL NOTIFY THE ARCHITECT/ENGINEER PRIOR TO PROCEEDING WITH THE WORK IF ANY DISCREPANCY IS FOUND BETWEEN THE VARIOUS ELEMENTS OF THE WORKING DRAWINGS AND THE TRUE NORTH ORIENTATION AS DEPICED ON THE PLAT OF SURVEY. THE CONTRACTOR WILL ASSUME SOLE LIABILITY FOR ANY FAILURE TO NOTIFY THE ARCHITECT/ENGINEER.



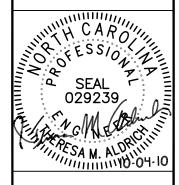

BASE TRANSCEIVER SITE
CATAWBA COLLEGE
2300 W. INNES ST.
SALISBURY, NC 28144
ROWAN COUNTY


PROJECT NUMBER: 10049.001 SHEET CONTENTS:

GENERAL NOTES AND SYMBOLS

SHEET NUMBER:



NOTE: THIS IS A GENERAL LEGEND. SOME ITEMS MAY NOT APPLY.

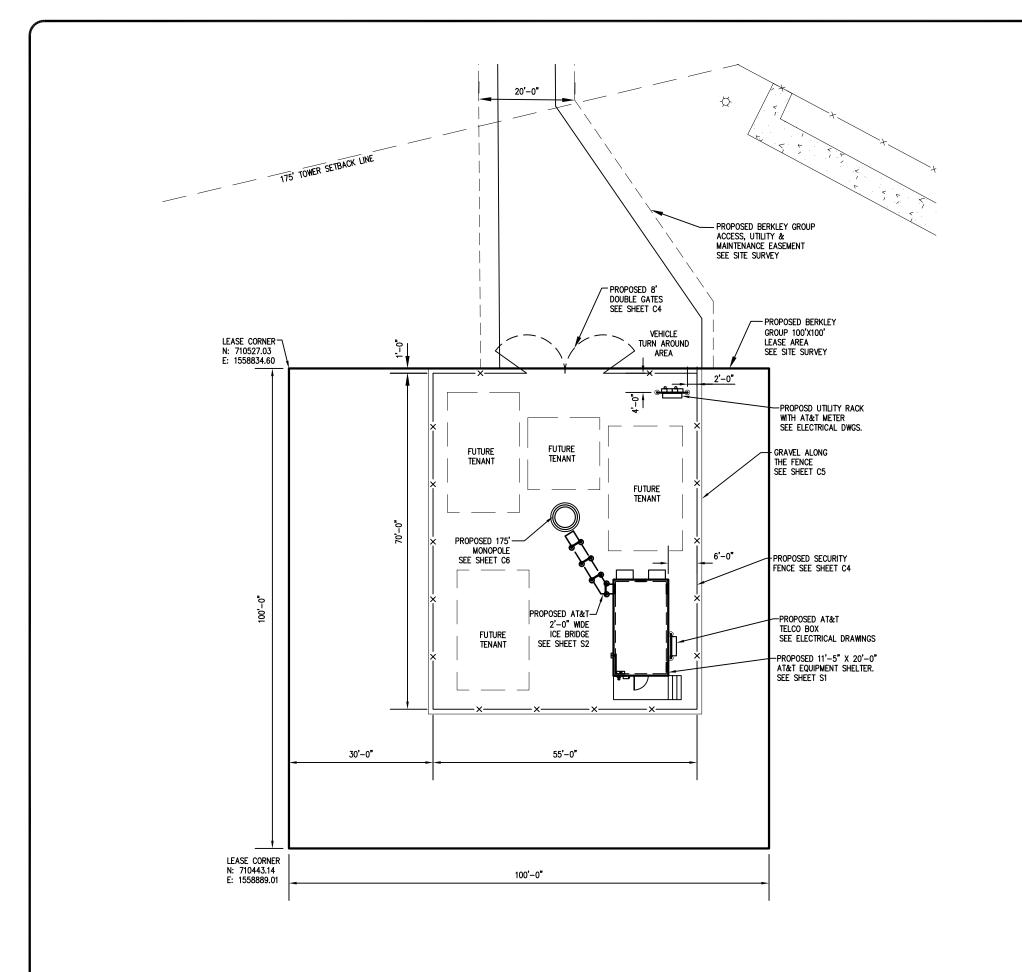



Engineering, Inc.
3 Marcus Drive
Greenville, SC 29615
Ph. (864) 288-0553
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SEAL 029239

SEAL 029239

MRSA M. ALORINIA

#### **GENERAL NOTES**

- 1. SEE G1 FOR GENERAL ABBREVIATIONS.
- 2. SEE C1 FOR GENERAL NOTES AND SYMBOLS.
- 3. SEE SITE SURVEY FOR LIMITS OF LEASE AREA AND ADDITIONAL SURVEY INFORMATION.
- 4. PARKING FOR SERVICE VEHICLES WILL BE PROVIDED IN THE VEHICLE TURNAROUND AREA.
- AFTER ALL HEAVY TRAFFIC IS COMPLETE (CONCRETE, TRUCKS, TRAILERS, DRILL RIG, ETC.) CONTRACTOR SHALL REGRADE THE ROAD/PARKING AREA COMPLETELY, ADDING AND COMPACTING ADDITIONAL CRUSHED STONE AS NEGESSARY.

CATAWBA COLLEGE PROPOSED 175' MONOPOLE LAT. = 35' 41' 35.46" N LONG. = 80' 29' 08.21" W ELEV.=658.28'



SE TRANSCEIVER SITI CATAWBA COLLEGE 2300 W. INNES ST.

BASE TI CATA 2300

SSUE REVISION ADDED UTILITY EASEMEN REV. ROBIN ROAD OF AW, REV. ROBIN ROAD COMPCY REVISED ODS	J DATE	10/04/10	T TO SURVEY 10/19/10	ADDED V3 10/26/10	JUND LOCATION 10/28/10	11/05/10			
	REVISION	Initial Issue	ADDED UTILITY EASEMENT TO SURVEY	REV. ROBIN ROAD R/W, ADDED V3	REV. TOWER AND COMPOUND LOCATION	REVISED CDs			

PROJECT NUMBER: 10049.001 SHEET CONTENTS:

LAYOUT PLAN

SHEET NUMBER:


SITE


C2



0' 20' 40' 60

GRAPHIC SCALE: 1" = 20'-0"

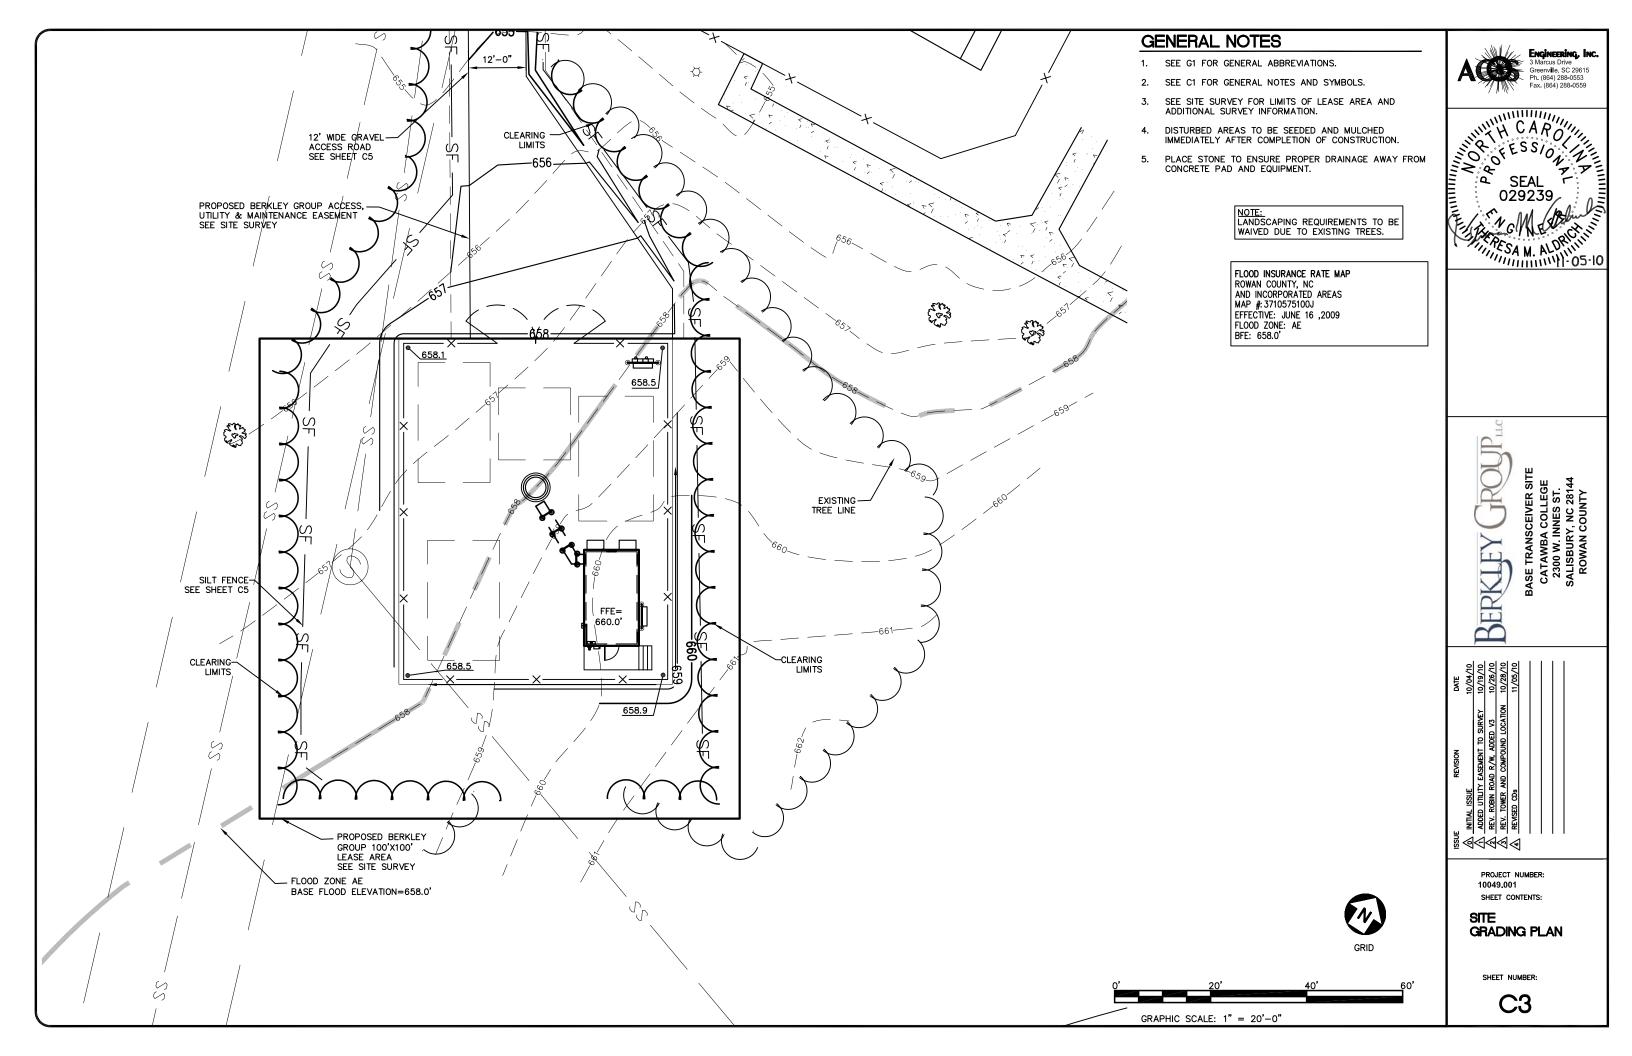

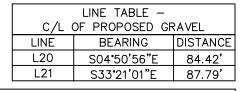


CURVE TABLE - C/L OF PROPOSED GRAVEL								
CURVE	E LENGTH RADIUS CHORD BEARING DELTA							
C20	39.85	235.00	39.81	S00°00'34"W	9°43'00"			
C21	24.87	50.00	24.62	S19°05'58"E	28°30'05"			

#### **GENERAL NOTES**

- SEE G1 FOR GENERAL ABBREVIATIONS.
- 2. SEE C1 FOR GENERAL NOTES AND SYMBOLS.
- SEE SITE SURVEY FOR LIMITS OF LEASE AREA AND ADDITIONAL SURVEY INFORMATION.
- DISTURBED AREAS TO BE SEEDED AND MULCHED IMMEDIATELY AFTER COMPLETION OF CONSTRUCTION.
- 5. PLACE STONE TO ENSURE PROPER DRAINAGE AWAY FROM CONCRETE PAD AND EQUIPMENT.



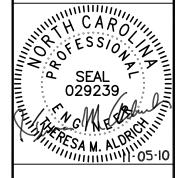



BASE TRANSCEIVE CATAWBA COLL 2300 W. INNES SALISBURY, NC 2

ISSUE	REVISION	DATE
آمر	Initial issue	10/04/10
اَے	ADDED UTILITY EASEMENT TO SURVEY	10/19/10
<u> </u>	REV. ROBIN ROAD R/W, ADDED V3	10/26/10
ক্	REV. TOWER AND COMPOUND LOCATION	10/28/10
_	REVISED CDs	11/05/10
1		


PROJECT NUMBER: 10049.001
SHEET CONTENTS:

ACCESS ROAD GRADING PLAN

SHEET NUMBER:


C3A

## PIPE OUTLET TO FLAT AREA - NO WELL DEFINED CHANNEL

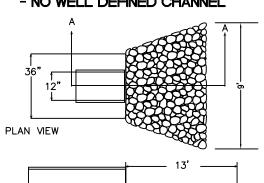



NOTES:

- 1. La is the length of the riprap apron.
- 2. d=1.5 times the maximum stone diameter but not less than 6".
- 3. In a well defined channel, extend the apron up the channel banks to an elevation of 6" above the maximum tailwater depth or to the bank, whichever is less.
- 4. A filter blanket or filter fabric should be installed between the riprap and soil foundation.

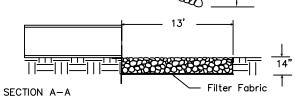


# 1 RIP-RAP APRON DETAIL C3A SCALE: N.T.S.

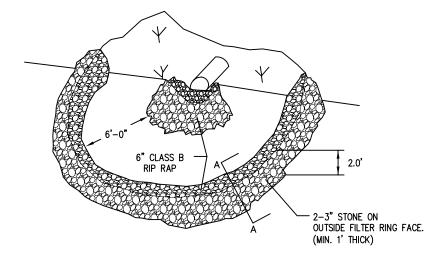


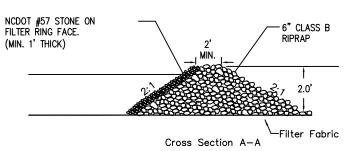


2 FILTER RING DETAIL
C3A SCALE: N.T.S.



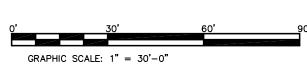

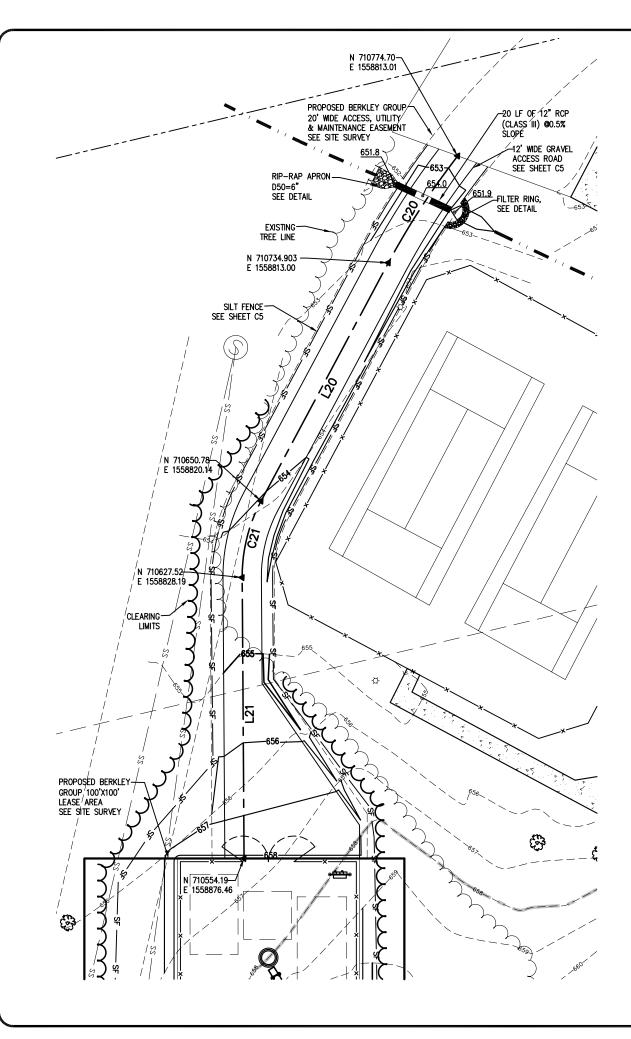

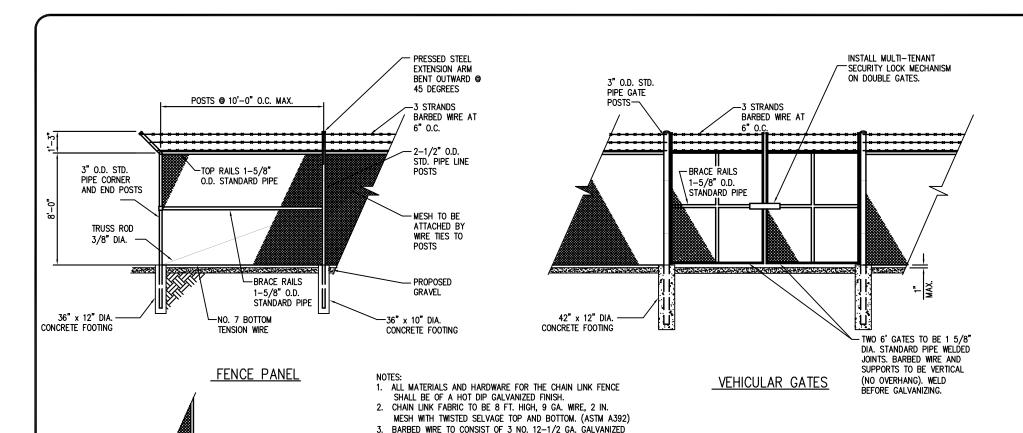

STEEL WIRE WITH 4 POINT BARBS OF NO. 14 GA. GALVANIZED STEEL.

8. TENSION BARS TO BE 3/16 x 3/4 INCH CARBON STEEL ATTACHED TO TERMINAL POSTS BY MEANS OF BEVELED EDGE BANDS.

PROVIDE TWO GATE KEEPER HOLD OPEN DEVICES FOR SWING GATES.
GATE KEEPERS TO ALLOW GATES TO OPEN APPROX. 180 DEGREES.
 PROVIDE COMBINATION LOCK FOR COMPOUND GATE AND ONE LOCK
FOR ANY OTHER GATE (I.E. ACCESS GATE, GUY WIRE FENCE GATE, ETC.)

STANDARD PANEL SECTION

4. POST, RAIL, AND GATE FITTINGS TO BE PRESSED STEEL OR

5. ALL POSTS SHALL HAVE WEATHER CAPS INSTALLED.

6. POSTS TO SET IN 2000 PSI CONCRETE. BOTTOM OF

CONCRETE TO BE 2" MIN. FROM BOTTOM OF POST.

7. TIE WIRES TO BE 9 GA. ALUMINUM SPACED AT 12" O.C. POSTS/GATES AND 24" O.C. RAILS/WIRE.

MALLEABLE CASTING. (ASTM A153)

6" x 6" x 3/8" BASE

PLATE ANCHORED TO

CONC. WITH HILTI

FASTENERS

ALT. POST ANCHOR DETAIL

FOR FASTENING TO CONCRETE

GATE KEEPER DETAIL

TO HOLD GATES OPEN


**GENERAL NOTES** 

- 1. SEE G1 FOR GENERAL ABBREVIATIONS.
- 2. SEE C1 FOR GENERAL NOTES AND SYMBOLS.




SHEET NUMBER:

C4

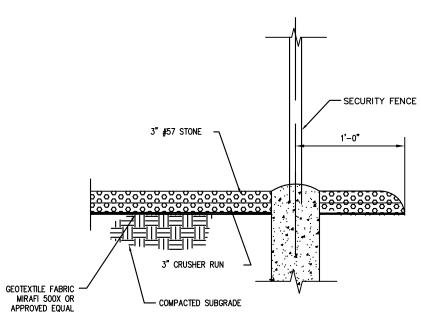




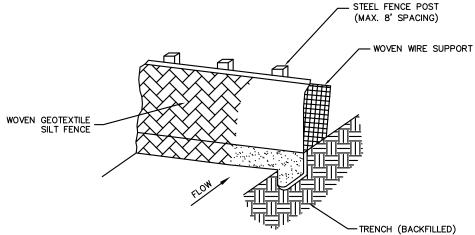


#### SILT FENCE NOTES:


- 1. STEEL POSTS WHICH SUPPORT THE SILT FENCE SHALL BE INSTALLED ON A SLIGHT ANGLE TOWARD THE ANTICIPATED RUNOFF SOURCE.
- 2. THE TOE OF THE SILT FENCE SHALL BE TRENCHED IN WITH A SPADE OR MECHANICAL TRENCHER, SO THAT THE DOWNSLOPE FACE OF THE TRENCH IS FLAT AND PERPENDICULAR TO THE LINE OF FLOW
- THE TRENCH SHOULD BE A MINIMUM OF 6 INCHES DEEP AND ALLOW FOR THE SILT FENCE TO BE LAID IN THE GROUND AND BACKFILLED.
- 4. SILT FENCE SHOULD BE SECURELY FASTENED TO WOVEN WIRE, WHICH IS IN TURN ATTACHED TO THE STEEL FENCE POSTS.
- INSPECTION SHALL BE FREQUENT AND REPAIR OR REPLACEMENT SHALL BE MADE PROMPTLY AS NEEDED.
- SILT FENCE SHALL BE REMOVED WHEN IT HAS SERVED ITS USEFULNESS, SO AS NOT TO BLOCK OR IMPEDE STORM FLOW OR DRAINAGE.
- ACCUMULATED SILT SHALL BE REMOVED WHEN IT REACHES A DEPTH OF 6 INCHES AND DISPOSED
  OF IN AN APPROVED SPOIL SITE.
- SILT FENCE SHALL BE A MINIMUM HEIGHT OF 30" MEASURED FROM THE EXISTING OR GRADED GROUND.
- SILT FENCE SHALL BE BURLAP, POLYPROPYLENE FABRIC, NYLON REINFORCED WITH POLYESTER NETTING OR OTHER MATERIAL (AS APPROVED & IF APPLICABLE). THE MULLEN BURST STRENGTH SHALL BE GREATER THAN 150 PSI. THE EDGES SHALL BE TREATED TO PREVENT UNRAVELING.




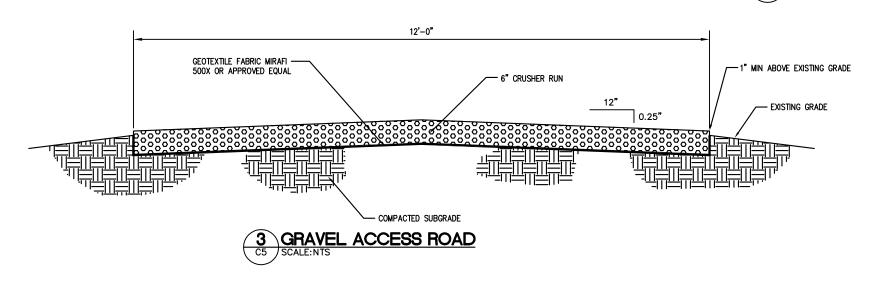

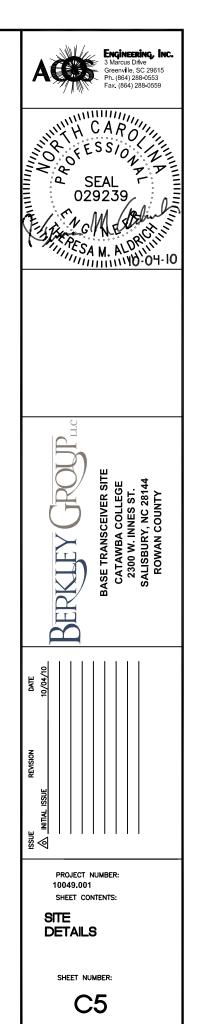

NOTE: THE TOWER DRAWING IS ONLY A GRAPHIC REPRESENTATION OF THE STRUCTURE. THE ACTUAL TOWER IN THE FIELD MAY VARY.

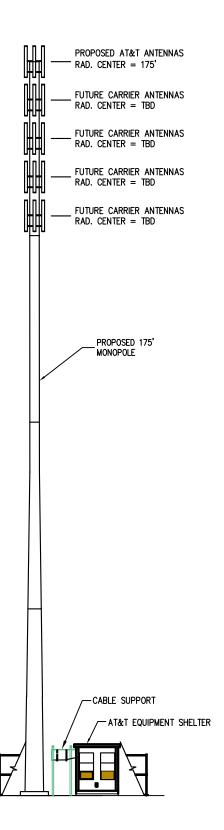


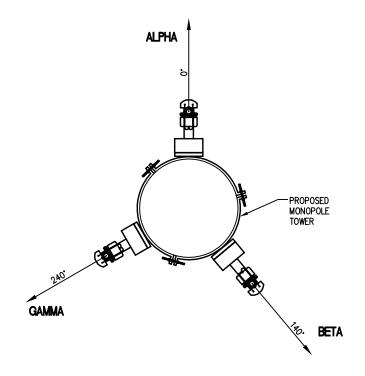




- ANTENNA CENTERLINE HEIGHT BASED ON TOP OF FOOTING ELEVATION.
- 2. ALL ANTENNA BRACKETS PER ANTENNA MANUFACTURER, OR EQUAL. CONTRACTOR TO COORDINATE REQUIRED MECHANICAL DOWNTILT WITH APPROPRIATE CARRIER.
- 3. ALL ANTENNA INFORMATION TO BE CONFIRMED WITH AT&T PRIOR TO INSTALLATION.



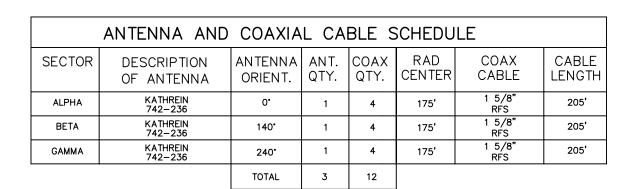

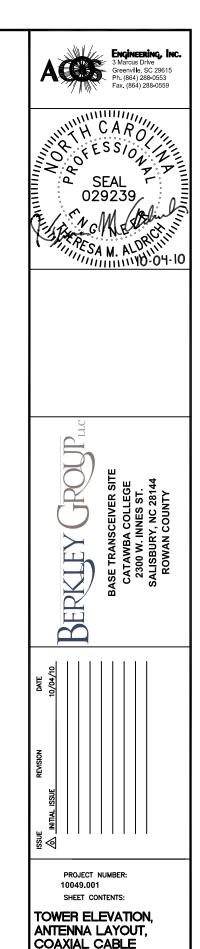


SHEET NUMBER:

C6

TOWER ELEVATION

C6 SCALE:NTS

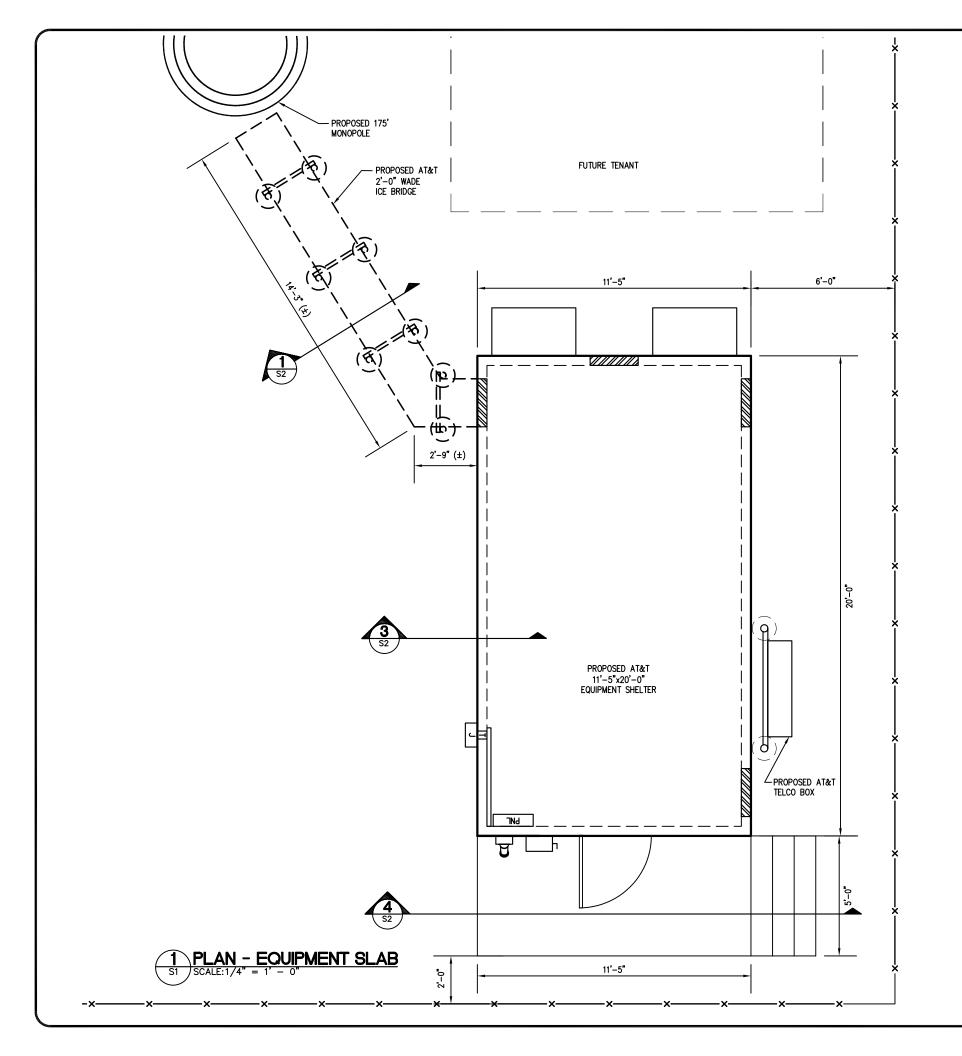

#### CONCRETE NOTES

1. PROVIDE CONCRETE THAT COMPLIES WITH THE FOLLOWING SCHEDULE:

ELEMENT	COMPRESSIVE STRENGTI © 28 DAYS (PSI)	I LINIT WEIGHT	MAX. COARSE AGGREGATE SIZE (INCHES)
FOOTINGS	4,000	150	3/4
SLABS, TRENCHES & CONDUIT ENCASEMENTS	3,500	150	3/4

- . PROVIDE NEW BILLET STEEL REINFORCING CONFORMING TO THE STANDARDS OF
- NOT USED.
- PROVIDE ANCHOR BOLTS CONFORMING TO THE STANDARDS OF ASTM A36 UNLESS OTHER WISE NOTED.
- PROVIDE DETAILING, FABRICATION, AND INSTALLATION OF REINFORCING IN ACCORDANCE WITH ACI 315 AND ACI 318.
- PROVIDE CLASS "B" REINFORCEMENT SPLICES. PROVIDE STANDARD 90 DEGREE HOOKS IN ACCORDANCE WITH ACI 318, UNLESS NOTED OTHERWISE. STAGGER SPLICES UNLESS SPECIFICALLY NOTED.
- MAINTAIN THE FOLLOWING COVERAGE FOR REINFORCING STEEL UNLESS ITS OTHERWISE NOTED:

CONCRETE CAST AGAINST EARTH	3"
CONCRETE EXPOSED TO WEATHER OR EARTH:	
NO. 6 AND LARGER	. 2"
NO. 5 AND SMALLER	. 1 1/2"
CONCRETE NOT EXPOSED TO WEATHER OR IN CONTACT W	ith ground
SLABS, WALLS & JOISTS	
NO. 11 AND SMALLER	3/4"
BEAM STIRRUPS & COLUMN TIES	
SHELLS AND FOLDED PLATE MEMBERS	
NO. 6 AND LARGER	3/4"
NO. 5 AND SMALLER	. 1/2"

- 8. ALL EXPOSED CONCRETE EDGES TO HAVE TOOLED FINISH.
- DO NOT WELD OR BEND ANY REINFORCEMENT IN THE FIELD UNLESS SPECIFICALLY SHOWN.
- D. WHERE REQUIRED, PROVIDE DOWELS TO MATCH THE SIZE AND SPACING OF THE
- 11. WIRE BRUSH AND CLEAN CONSTRUCTION JOINTS IMMEDIATELY PRIOR TO POURING NEW CONCRETE.
- 12. CAREFULLY COORDINATE THE PLACEMENT OF CAST-IN-PLACE EMBEDS AND ANCHOR BOLTS. SET ANCHOR BOLTS WITH A TEMPLATE. SECURELY ATTACH ALL EMBED ITEMS TO FORM WORK OR REINFORCING.

#### **GENERAL NOTES**

- VERIFY EXISTING CONDITIONS AND DIMENSIONS PRIOR TO
   BEGINNING WORK OR FABRICATING MATERIALS. NOTIFY A/E OF
   DISCREPANCIES BEFORE PROCEEDING WITH ANY PHASE OF WORK.
   DO NOT SCALE CONTRACT DRAWINGS FOR THE PURPOSE OF
- ESTABLISHING DIMENSIONS.
- 3. DETAILS LABELED "TYPICAL DETAILS" ON DRAWINGS APPLY TO SITUATIONS OCCURRING ON THE PROJECT THAT ARE THE SAME OR SIMILAR TO THOSE SPECIFICALLY DETAILED. SUCH DETAILS TO APPLY WHETHER OR NOT THEY ARE KEYED IN AT EACH LOCATION. QUESTIONS REGARDING APPLICABILITY OF "TYPICAL DETAILS," TO BE DETERMINED BY THE ENGINEER.
- CONTRACTOR TO BE RESPONSIBLE FOR DESIGN, ADEQUACY AND SAFETY OF ERECTION BRACING, SHORING, TEMPORARY SUPPORTS AND OTHER METHODS OF CONSTRUCTION.
- PROVIDE MEASURES NECESSARY TO PROTECT THE STRUCTURE AND SAFETY OF WORKMEN DURING CONSTRUCTION. COMPLY WITH APPLICABLE REQUIREMENTS OF OSHA AND OTHER GOVERNING BODIES HAVING JURISDICTION AT THE SITE.
- STRIP EXISTING GRADE OF ALL TOPSOIL, VEGETATION AND OTHER UNDESIRABLE MATERIALS. REPLACE ANY SOFT AREAS WITH WELL-COMPACTED FILL.
- WELL-COMPACTED FILL.

  7. DO NOT PLACE CONCRETE AGAINST SUBGRADE CONTAINING FREE WATER, FROST OR ICE.
- . OPEN EXCAVATIONS MUST REMAIN DRY. BACKFILL AGAINST FOUNDATIONS AS SOON AS PRACTICAL. PUMP OPEN EXCAVATIONS OF WATER IF EXCAVATIONS ARE FLOODED PRIOR TO BACKFILLING. KEEP WATER OR DRAINAGE LINES AT LEAST 10 FT AWAY FROM THE LOCATION OF THE PROPOSED FOUNDATION.



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SERKLEY GROUP BASE TRANSCEIVER SITE


PROJECT NUMBER: 10049,001
SHEET CONTENTS:

EQUIPMENT SLAB PLAN AND NOTES

SHEET NUMBER:

S1

W

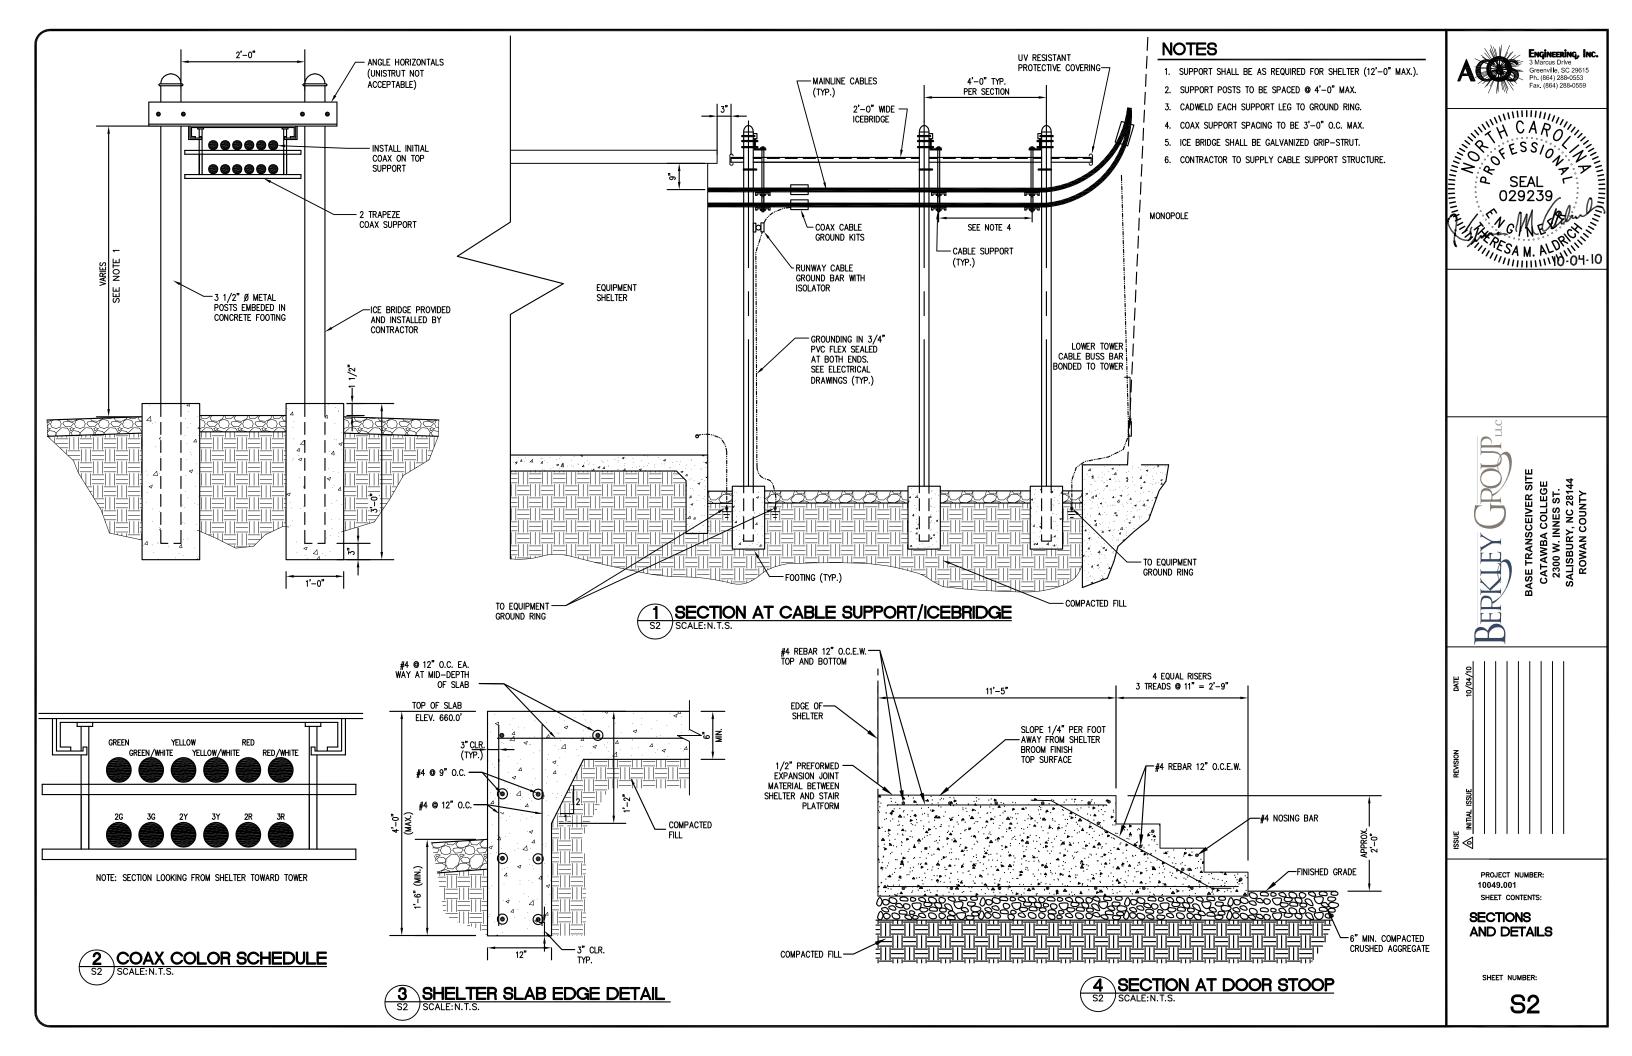

#### **GENERAL CONSTRUCTION NOTES:**

- 1. THE FACILITY IS AN UNOCCUPIED WIRELESS FACILITY.
- PLANS ARE NOT TO BE SCALED AND ARE INTENDED TO BE A DIAGRAMMATIC OUTLINE ONLY, UNLESS NOTED OTHERWISE. THE WORK WILL INCLUDE PROVIDING MATERIALS, EQUIPMENT, APPURTENANCES, AND LABOR NECESSARY TO COMPLETE ALL INSTALLATIONS AS INDICATED ON THE DRAWINGS.
- 3. ALL EXISTING UTILITIES, FACILITIES, CONDITIONS, AND THEIR DIMENSIONS SHOWN ON PLANS HAVE BEEN PLOTTED FROM AVAILABLE RECORDS. THE ARCHITECT/ENGINEER AND OWNER ASSUME NO RESPONSIBILITY AS TO SUFFICIENCY OR ACCURACY OF THE INFORMATION SHOWN ON THE PLANS OR THE MANNER OF THEIR REMOVAL OR ADJUSTMENT. CONTRACTOR SHALL BE RESPONSIBLE FOR DETERMINING EXACT LOCATION OF EXISTING UTILITIES AND FACILITIES PRIOR TO START OF CONSTRUCTION. CONTRACTOR SHALL ALSO OBTAIN FROM EACH UTILITY COMPANY, DETAILED INFORMATION RELATIVE TO WORKING SCHEDULES AND METHODS OF REMOVING OR ADJUSTING EXISTING UTILITIES.
- 4. PRIOR TO THE SUBMISSION OF BIDS, THE CONTRACTORS WILL VISIT THE JOB SITE AND BE RESPONSIBLE FOR ALL CONTRACT DOCUMENTS, FIELD CONDITIONS AND DIMENSIONS, AND CONFIRMING THAT THE WORK MAY BE ACCOMPLISHED AS SHOWN PRIOR TO PROCEEDING WITH CONSTRUCTION. ANY DISCREPANCIES ARE TO BE BROUGHT TO THE ATTENTION OF THE IMPLEMENTATION ENGINEER AND ARCHITECT/ENGINEER PRIOR TO PROCEEDING WITH THE WORK.
- 5. WRITTEN AUTHORIZATION IS REQUIRED BEFORE STARTING WORK ON ANY ITEM NOT CLEARLY DEFINED OR IDENTIFIED BY THE CONTRACT DOCUMENTS.
- PRIOR TO SITE EXCAVATION, CONTRACTOR SHALL LOCATE EXISTING SERVICES.
   DAMAGE CAUSED TO EXISTING SERVICES SHALL BE REPAIRED BY CONTRACTOR AT CONTRACTOR'S EXPENSE.
- 7. INSTALL ALL EQUIPMENT AND MATERIALS IN ACCORDANCE WITH MANUFACTURER'S RECOMMENDATIONS UNLESS SPECIFICALLY INDICATED OTHERWISE OR WHERE LOCAL CODES OR REGULATIONS TAKE PRECEDENCE.
- 8. ALL WORK PERFORMED AND MATERIALS INSTALLED WILL BE IN STRICT ACCORDANCE WITH ALL APPLICABLE CODES, REGULATIONS, AND ORDINANCES INCLUDING THE 2009 NC BUILDING CODE, 2008 NEC AND 2006 IBC WITH NC AMENDMENTS. THE CONTRACTOR WILL GIVE ALL NOTICES AND COMPLY WITH ALL LAWS, ORDINANCES, RULES, REGULATIONS, AND LAWFUL ORDERS OF ANY PUBLIC AUTHORITY REGARDING THE PERFORMANCE OF THE WORK. ELECTRICAL SYSTEMS SHALL BE INSTALLED IN ACCORDANCE WITH ALL APPLICABLE MUNICIPAL AND UTILITY COMPANY SPECIFICATIONS, AND LOCAL AND STATE JURISDICTIONAL CODES, ORDINANCES, AND APPLICABLE REGULATIONS.
- 9. THE GENERAL CONTRACTOR WILL SUPERVISE AND DIRECT THE WORK USING THE BEST SKILLS AND ATTENTION. THE CONTRACTOR WILL BE SOLELY RESPONSIBLE FOR ALL CONSTRUCTION MEANS, METHODS, TECHNIQUES, SEQUENCES, AND PROCEDURES AND FOR COORDINATING ALL PORTIONS OF THE WORK UNDER THE CONTRACT INCLUDING CONTACT AND COORDINATION WITH THE OWNER AND WITH THE LANDLORD'S AUTHORIZED REPRESENTATIVE.
- 10. DETAILS ARE INTENDED TO SHOW END RESULT OF DESIGN. MINOR MODIFICATIONS MAY BE REQUIRED TO SUIT JOB DIMENSIONS OR CONDITIONS, AND SUCH MODIFICATIONS WILL BE INCLUDED AS PART OF THE WORK.
- 11. REPRESENTATIONS OF TRUE NORTH, OTHER THAN THOSE FOUND ON THE PLAT OF THE SURVEY DRAWING, WILL NOT BE USED TO IDENTIFY OR ESTABLISH THE BEARING OF TRUE NORTH AT THE SITE. THE CONTRACTOR WILL RELY SOLELY ON THE PLAT OF SURVEY DRAWING AND ANY SURVEYOR'S MARKINGS AT THE SITE FOR THE ESTABLISHMENT OF TRUE NORTH, AND WILL NOTIFY THE ARCHITECT/ENGINEER PRIOR TO PROCEEDING WITH THE WORK IF ANY DISCREPANCY IS FOUND BETWEEN THE VARIOUS ELEMENTS OF THE WORKING DRAWINGS AND THE TRUE NORTH ORIENTATION AS DEPICTED ON THE PLAT OF SURVEY. THE CONTRACTOR WILL ASSUME SOLE LIABILITY FOR ANY FAILURE TO NOTIFY THE ARCHITECT/ENGINEER.
- 12. COORDINATE WORK WITH LOCAL UTILITY COMPANY AND CONSTRUCT TO UTILITY COMPANY ENGINEERING PLANS AND SPECIFICATIONS. PROVIDE TRENCHING AND BACKFILL, AND PAY ALL UTILITY FEES UNLESS NOTED OTHERWISE. THE WORK WILL INCLUDE PROVIDING MATERIALS, EQUIPMENT, APPURTENANCES, AND LABOR NECESSARY TO COMPLETE ALL INSTALLATIONS AS INDICATED ON THE DRAWINGS.
- 13. BEFORE PURCHASING EQUIPMENT, THE ELECTRICAL CONTRACTOR SHALL CONTACT THE POWER COMPANY AND GET IN WRITING THE MAXIMUM SHORT CIRCUIT CURRENT THE POWER COMPANY IS FURNISHING TO THE POINT OF SERVICE. ALL EQUIPMENT SHALL BE RATED AND COORDINATED TO NO LESS THAN THE MAXIMUM SHORT CIRCUIT CURRENT PROVIDED BY POWER COMPANY, WITH A MINIMUM SHORT CIRCUIT RATING OF 10,000 AMPS.


#### SERVICE ROUTING NOTES: (DWG E2)

- CONTRACTOR SHALL TERMINATE THE POWER CABLES AT THE UTILITY METER LOCATED AT THE METER CENTER. COORDINATE EXACT METER BASE TYPE AND REQUIREMENTS WITH LOCAL UTILITY.
- P. CONDUIT LINES SHALL HAVE A CONTINUOUS SLOPE DOWNWARD AND AWAY FROM THE EQUIPMENT TO THE PROPERTY LINE SO THAT WATER WILL FLOW AWAY FROM THE EQUIPMENT. TRENCHES SHALL BE EXCAVATED ALONG STRAIGHT LINES BEFORE CONDUITS ARE LAID SO THAT THE ELEVATION CAN BE ADJUSTED, IF NECESSARY, TO AVOID UNSEEN OBSTRUCTIONS. MANUFACTURED BENDS SHALL HAVE A MINIMUM RADIUS OF 36" FOR CONDUITS.
- ALL CONDUITS SHALL BE SEALED WEATHER TIGHT ON INTERIOR AND EXTERIOR
  OF EQUIPMENT TO PREVENT MOISTURE INFILTRATION. SEALANTS SHALL BE
  IDENTIFIED FOR USE WITH THE CABLE INSULATION SHIELD OR OTHER
  COMPONENTS
- 4. CELLULAR EQUIPMENT SHELTER SHALL BE FURNISHED BY RESPECTIVE CARRIER AND INSTALLED BY CONTRACTOR. CONTRACTOR SHALL OBTAIN SHELTER DRAWINGS AND SPECIFICATIONS TO VERIFY EXACT INSTALLATION DETAILS AND REQUIREMENTS WHICH MAY NOT BE SPECIFICALLY ADDRESSED WITHIN THESE DRAWINGS.
- CONTRACTOR SHALL FURNISH AND INSTALL PULL BOXES IN CONDUIT RUNS AT EACH OCCURRENCE WHERE EXCEEDING 360 DEGREES IN TOTAL BENDS OR 300' IN LENGTH AT A CONVENIENT INTERMEDIATE LOCATION. PULL BOXES SHALL BE SIZED PER NEC 370.
- 6. ON SPARE CONDUITS, PROVIDE 2 PULL STRINGS SECURELY FASTENED AT EACH END OF THE CONDUITS. PULL STRINGS SHALL BE 200LB TEST POLYETHYLENE CORD. PROVIDE CAP ON END OF THE CONDUITS AND MARK AS SHOWN ON THE SERVICES ROUTING PLAN.
- MAINTAIN MINIMUM BENDING RADIUS FOR CONDUIT INSTALLATIONS PER CONDUIT/FIBER MANUFACTURER RECOMMENDATIONS.
- 8. REFERENCE E4 FOR ONE-LINE, CONDUIT AND WIRE SIZE, AND SPECIFICATIONS.
- PROVIDE MINIMUM OF 36 INCHES WORK CLEARANCE IN FRONT OF EQUIPMENT AND EQUIPMENT RACKS.
- WARNING TAPE SHALL BE PLACED IN TRENCHES AND SHALL READ EITHER "UTILITIES" OR "ELECTRIC".
- 11. ENDS OF WARNING TAPE SHALL EXTEND 6" MINIMUM ABOVE FINAL GRADE.
- ALL CONDUIT SHALL BE SCHEDULE 40 OR 80 PVC UNLESS NOTED OTHERWISE. EXPOSED CONDUIT SHALL BE UV RESISTANT.


#### GROUNDING NOTES: (DWG E3)

- ALL DETAILS ARE SHOWN IN GENERAL TERMS. ACTUAL GROUNDING INSTALLATION REQUIREMENTS AND CONSTRUCTION MAY VARY ACCORDING TO SITE CONDITIONS. VERIFY EXACT EQUIPMENT GROUNDING WITH EQUIPMENT MANUFACTURER AND OWNER.
- GROUND RODS SHALL BE DRIVEN AT 10'-0" INTERVALS OF THE GROUND RING OR RADIALS. GROUND RODS SHALL NOT BE PLACED CLOSER THAN 6'-0" APART PER NEC 250-56.
- INSTALL GROUND CONDUCTORS AND GROUND RODS A MINIMUM OF 24" (MAXIMUM 36") FROM EQUIPMENT CONCRETE SLAB, SPREAD FOOTING, OR FENCE.
- 4. ALL BELOW GRADE CONNECTIONS: EXOTHERMIC WELD TYPE; ABOVE GRADE CONNECTIONS: EXOTHERMIC WELD TYPE (FENCE AND TOWER) OR MECHANICAL TYPE (2—HOLE LUGS WITH MECHANICAL CONNECTORS AT EQUIPMENT). ALL HARDWARE SHALL BE STAINLESS STEEL WITH LOCKWASHERS.
- CLEAN EXOTHERMIC WELD CONNECTIONS ON GALVANIZED SURFACES THOROUGHLY AND COVER W/ (2) TWO COATS SHERWIN WILLIAMS GALVITE PAINT B350W3 (OR EQUIVALENT).
- ALL ELECTRICAL AND MECHANICAL GROUND CONNECTIONS SHALL BE TO BARE BRIGHT SURFACES AND HAVE ANTI-OXIDATION COMPOUND APPLIED TO CONNECTION (THOMAS AND BETTS KOPR-SHIELD).
- 7. THE MINIMUM BEND RADIUS FOR GROUND CONDUCTORS SHALL BE 8 INCHES FOR #6 AWG WIRE AND 12 INCHES FOR #2 AWG AND GREATER WIRE.
- 8. ITEMS TO BE BONDED TO THE GROUND RING INCLUDE BUT ARE NOT LIMITED TO: CORNER FENCE POSTS AND FENCE POSTS WITHIN 6' OF GROUND RING, GROUND BUS BARS, EQUIPMENT CABINETS, EQUIPMENT RACKS, CABLE SUPPORT STRUCTURES, TOWER, GENERATOR, ANY OTHER METAL OBJECTS WITHIN 6' OF GROUND RING
- 9. GROUNDING INSTALLATIONS AND CONNECTIONS SHALL BE MADE BY ELECTRICAL CONTRACTOR
- OBSERVE N.E.C. AND LOCAL UTILITY REQUIREMENTS FOR ELECTRICAL SERVICE GROUNDING.
- 11. GROUNDING ATTACHMENT TO TOWER SHALL BE PER MANUFACTURER'S
  RECOMMENDATIONS OR AT GROUNDING POINTS PROVIDED (3 MINIMUM).
- 12. GROUND COAXIAL RF CABLES USING GROUND KITS TO GROUND BARS AT TOP, MIDDLE, AND BOTTOM OF TOWER, SEE DRAWING E7 FOR DETAILS.
- 13. ALL EXPOSED GROUND LEADS SHALL BE ROUTED INSIDE 1/2" (MIN.) PVC OR FLEXIBLE PVC CONDUIT (NON-METALLIC), TO 18" (MIN.) BELOW GRADE.

#### **ABBREVIATIONS** A, AMP AMPERES 1 TG LIGHTING ABT ABOUT MASTER ISOLATED GROUND MIGR AFF ABOVE FINISHED FLOOR MCB MAIN CIRCUIT BREAKER AFG ABOVE FINISHED GRADE MLO MAIN LUGS ONLY AWG AMERICAN WIRE GAUGE MTD MOUNTED BCW BARE COPPER WIRE N NFUTRAL BLDG BUILDING NEC NATIONAL ELECTRICAL CODE BTS BASE TRANSMISSION SYSTEM NOT IN CONTRACT NIC CONDUIT NO NUMBER CAT CATALOG NTS NOT TO SCALE COAX ISOLATED GROUND BAR CIGBE PPC POWER PROTECTION CABINET CKT CIRCUIT RECEPT RECEPTACLE RGS RIGID GALVANIZED STEEL DWG DRAWING(S REQD REQUIRED EQPT FOUIPMENT SCHEDULE EXIST FXISTING SCH TYPICAL FURNISHED BY OTHERS TYP FB0 UNDERGROUND UG FWE FURNISHED W/ EQUIPMENT UNLESS NOTED OTHERWISE UNO GFI GROUND FAULT INTERRUPTER V VOLT(S) GND GROUND INDICATES WEATHERPROOF GPS GLOBAL POSITIONING SYSTEM WP TRANSFORMER XFMR JΒ JUNCTION BOX

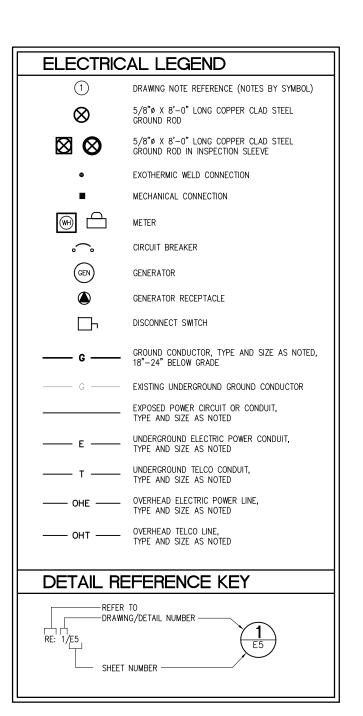



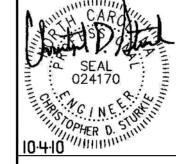





PROJECT NUMBER: 10049.001 SHEET CONTENTS:

GENERAL ELECTRICAL NOTES AND LEGEND

SHEET NUMBER:

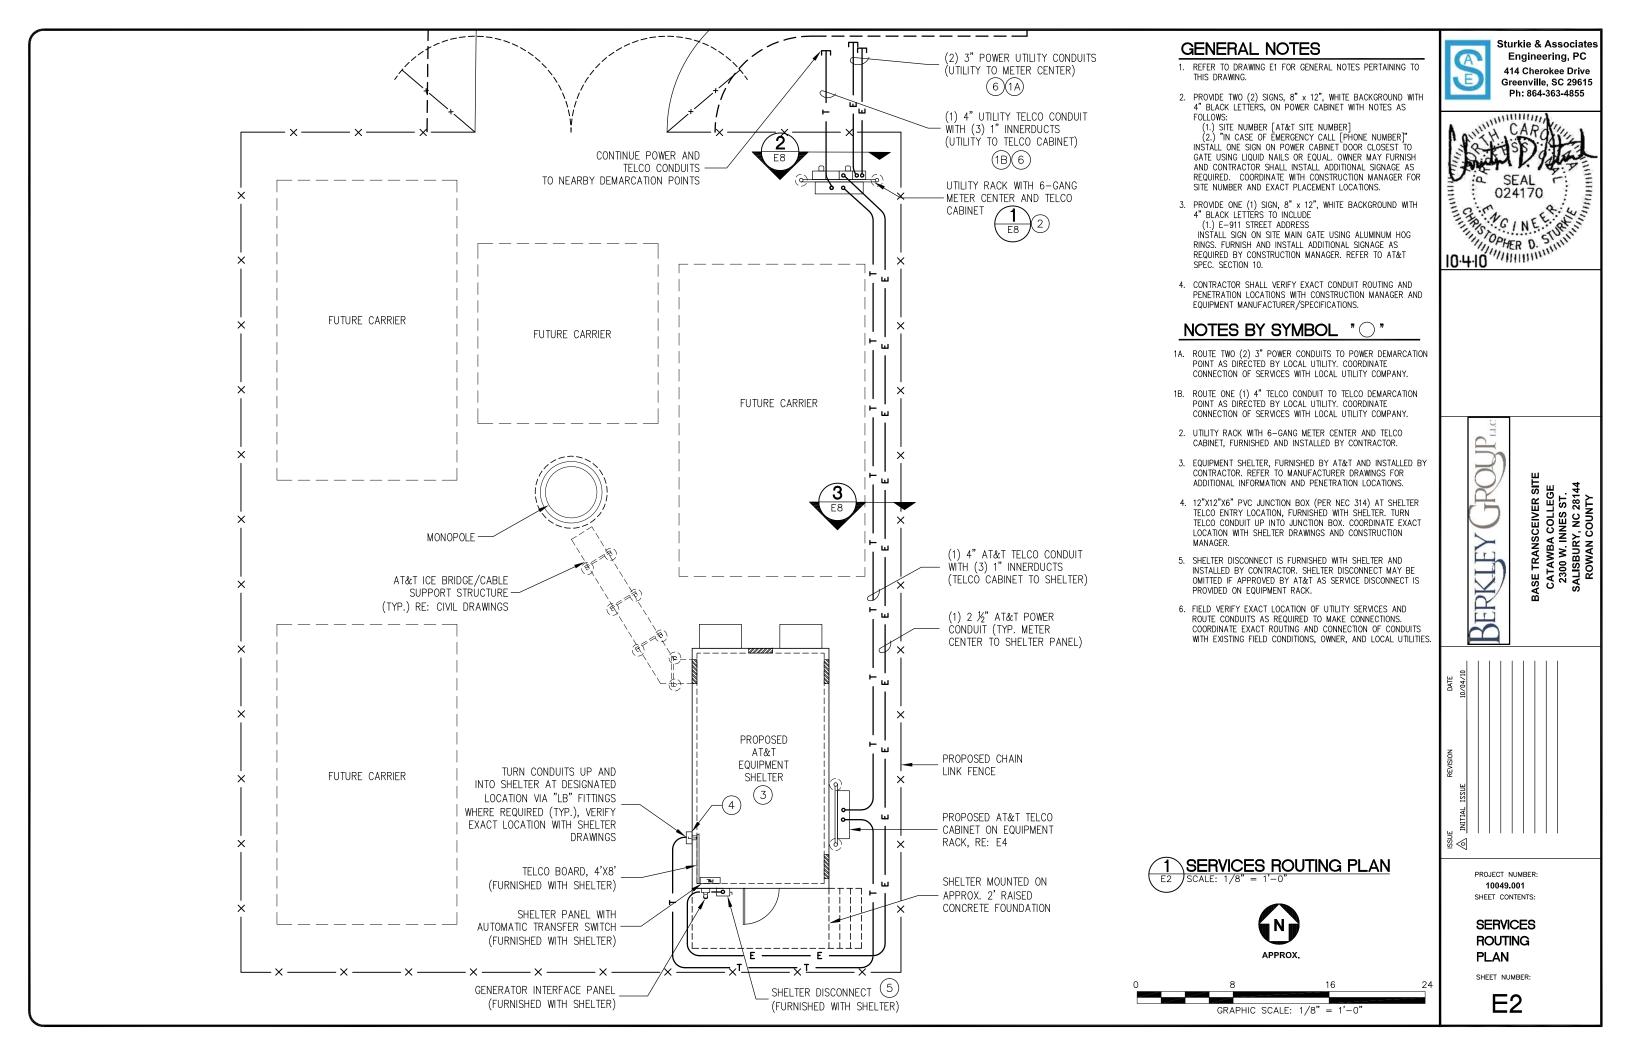

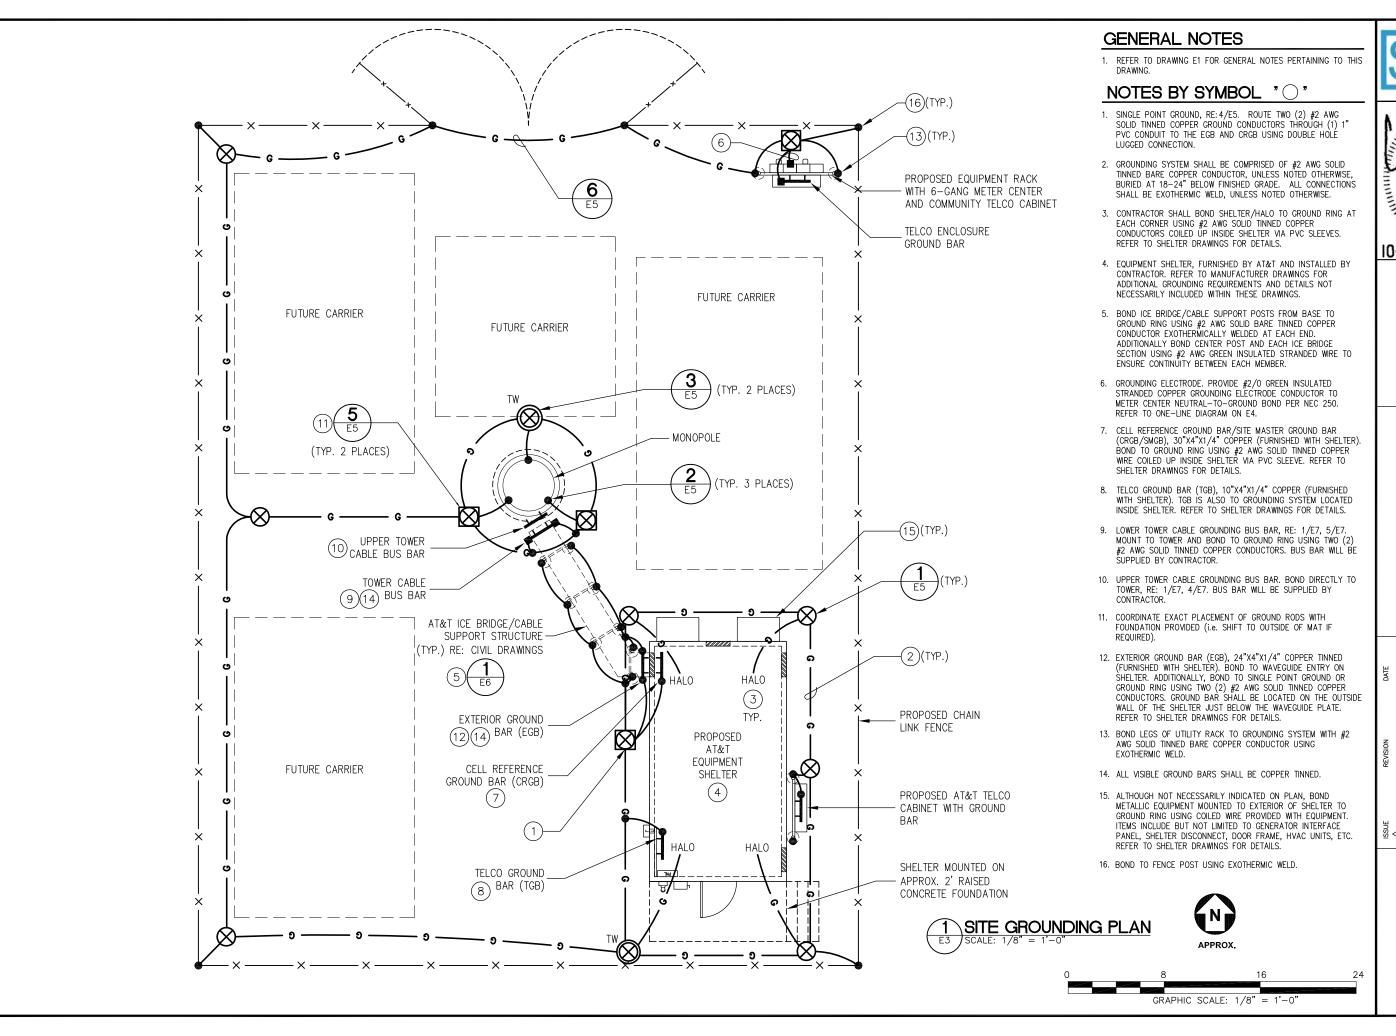




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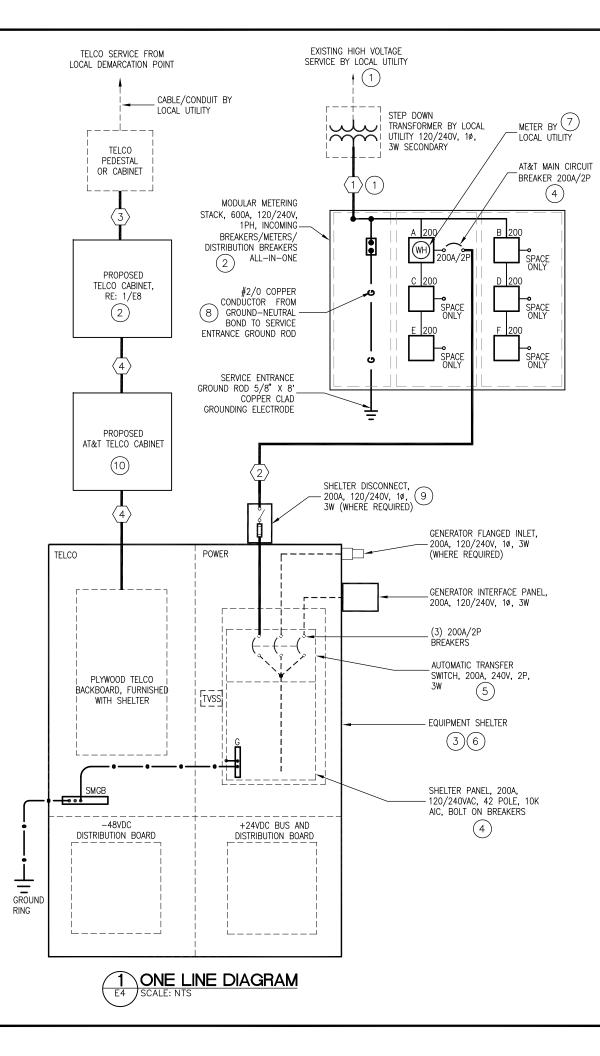




PROJECT NUMBER: 10049.001
SHEET CONTENTS:

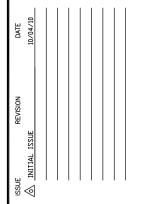SITE GROUNDING PLAN

SHEET NUMBER:



# ONE LINE DIAGRAM NOTES BY SYMBOL "

- CONTRACTOR SHALL FURNISH AND INSTALL NEW CONDUITS AND CONDUCTORS FROM EQUIPMENT TO POWER AND TELCO DEMARCATION POINTS AS INDICATED. COORDINATE WITH LOCAL UTILITIES FOR CONNECTION OF SERVICES.
- CONTRACTOR SHALL PROVIDE METER CENTER, TELCO CABINET, AND ASSOCIATED RACKS/CONDUITS. REFER TO E8 FOR RACK ELEVATION DETAILS AND EQUIPMENT SPECIFICATIONS
- 3. EQUIPMENT SHELTER SHALL BE FURNISHED BY CARRIER AND SHALL BE INSTALLED BY CONTRACTOR. ALL ITEMS SHOWN WITHIN SHELTER ARE PROVIDED WITH THE SHELTER AND ARE SHOWN FOR REFERENCE ONLY UNLESS NOTED OTHERWISE. PROVIDE THE CONNECTIONS INDICATED. OBTAIN SHELTER DRAWINGS FOR CIRCUIT CONNECTIONS, BREAKER AND CONDUCTOR SIZES. AND ADDITIONAL INFORMATION.
- CONTRACTOR SHALL PROVIDE ALL CIRCUIT BREAKERS REQUIRED TO FEED AT&T EQUIPMENT. CONTRACTOR SHALL LABEL ALL CIRCUIT BREAKERS WITH RESPECT TO WHAT THEY FEED.
- 5. EQUIPMENT SHELTER IS EQUIPPED WITH TRANSFER SWITCH FOR GENERATOR CONNECTIONS.
  REFER TO SHELTER DRAWINGS FOR DETAILS. BREAKERS ARE INERLOCKED TO ALLOW ONLY 1
  BREAKER CLOSED AT ANY GIVEN TIME
- 6. THE CONTRACTOR SHALL REFER TO SHELTER DRAWINGS AND SPECIFICATIONS FOR CONTROL AND ALARM WIRING. INTERIOR ALARMS ARE PRE—WIRED.
- CONTRACTOR SHALL PROVIDE AND INSTALL NAMEPLATE ON METER TO INDICATE "AT&T".
   NAMEPLATES SHALL BE PHENOLIC, WHITE LETTERS ON BLACK BACKGROUND.
- CONTRACTOR SHALL BOND NEUTRAL TO GROUND AT ONE LOCATION ONLY PER NEC 250 AND LOCAL CODE REQUIREMENTS.
- 9. SHELTER DISCONNECT IS FURNISHED WITH SHELTER. ON SITES WHERE SERVICE IS OBTAINED FROM AN EXISTING SOURCE (METER CENTER), DISCONNECT MAY BE OMITTED.
- CONTRACTOR SHALL PROVIDE AND INSTALL TELCO CABINET, 48"Hx48"Wx12"D WITH GROUND BAR. COORDINATE EXACT REQUIREMENTS WITH OWNER/AT&T CONSTRUCTION MANAGER.


#### **GENERAL NOTES**

- CONTRACTOR SHALL COORDINATE INCOMING SERVICES WITH LOCAL UTILITIES PRIOR TO TRENCHING.
- 2. ALL CONDUCTORS SHALL BE COPPER, 75 DEGREES C RATED, AND CONDUCTOR INSULATION SHALL BE THWN OR THHN.
- 3. ALL TERMINATIONS SHALL BE LISTED AND IDENTIFIED FOR USE WITH 75°C RATED CONDUCTORS OPERATING AT 75°C.
- 4. GROUND FAULT PROTECTION REQUIRED FOR UTILITY RECEPTACLES.
- 5. SERVICE NEUTRAL SHALL BE GROUNDED AT ONE LOCATION ONLY.
- 6. WHITE/NEUTRAL, GREEN/GROUND SHALL BE MAINTAINED THROUGHOUT THE SITE ELECTRICAL SYSTEM (TAPE WILL NOT BE ACCEPTABLE).
- 7. EQUIPMENT LOCATED OUTSIDE OR EXPOSED TO MOISTURE SHALL BE NEMA 3R RATED.
- 8. CONTRACTOR SHALL USE SCHEDULE 80 PVC CONDUIT THROUGHOUT, UNLESS OTHERWISE NOTED.
- 3. ALL NEWLY INSTALLED EQUIPMENT SHALL BE RATED AT 10K AIC MINIMUM. HIGHER RATINGS SHALL BE REQUIRED WHERE AVAILABLE FAULT CURRENT AVAILABLE SHALL BE COORDINATED WITH LOCAL UTILITY BASED ON EXACT CONDITIONS (XFMR SIZE, PERCENT IMPEDANCE, LENGTH OF CONDUCTORS, ETC).


	CABLE AND CONDUIT SCHEDULE												
MARK	APK CO		DNDUIT		WIRES EACH CONDUIT		EQUIPMENT				то.	DECDONICIDII ITV	DEMARKS
IVIAINI	QTY	SIZE	TYPE	QTY	SIZE	GROUND	VOLTS	AMPS	SUB. CAT.	FROM	ТО	RESPONSIBILITY	REMARKS
$\langle 1 \rangle$	2	3"	PVC	3	350 kCMIL		240	600	AC POWER	XFMR/DEMARC	METER/ SERVICE DISC	UTILITY/CONTRACTOR	INCOMING POWER BY LOCAL UTILITY
2	1	2 ½"	PVC	3	#3/0	#4	240	200	AC POWER	SVC DISC	SHELTER PNL	NSOR0	POWER TO SHELTER
(3)	1	4"	PVC	WITH	(3) 1" IN	NERDUCTS			TELCO	DEMARC	HOFFMAN BX	UTILITY	INCOMING TELCO BY LOCAL UTILITY
4	1	4"	PVC	- (1) 2	25 PR CAT 5	NERDUCTS e SHIELDED ER FOR FIBER			TELCO	COMMUNITY HOFFMAN BX	SHELTER	NSORO	25 PAIR AND 24 VDC POWER FOR FIBER VIA AT&T TELCO CABINET

FAULT CURRENT SUMMARY TABLE									
5	AVAIL	ABLE FAULT CURR	ENT (AMPS RMS SYMMETRICAL)						
FAULT LOCATION	SCA L-L	SCA L-N	REMARKS						
TRANSFORMER SECONDARY (*)	13,021	19,533	ASSUMING INFINITE AVAILABLE ON PRIMARY						
METER CENTER	10,935	12,420	IMPEDANCE - 40' INCOMING SERVICE CONDUCTORS						
SHELTER MAIN CIRCUIT BREAKER	8,021	6,805	IMPEDANCE - 50' FEEDER CONDUCTORS, MC TO SHELTER						

\* USING 50KVA, 120/240V, 1 PHASE TRANSFORMER, 1.6% IMPEDANCE

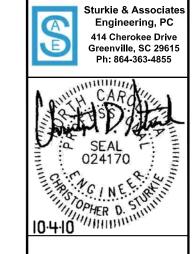




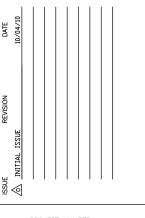


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ONE LINE


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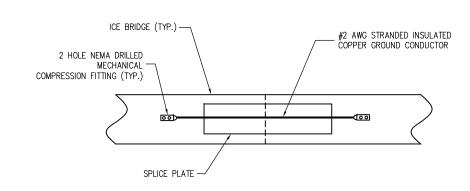


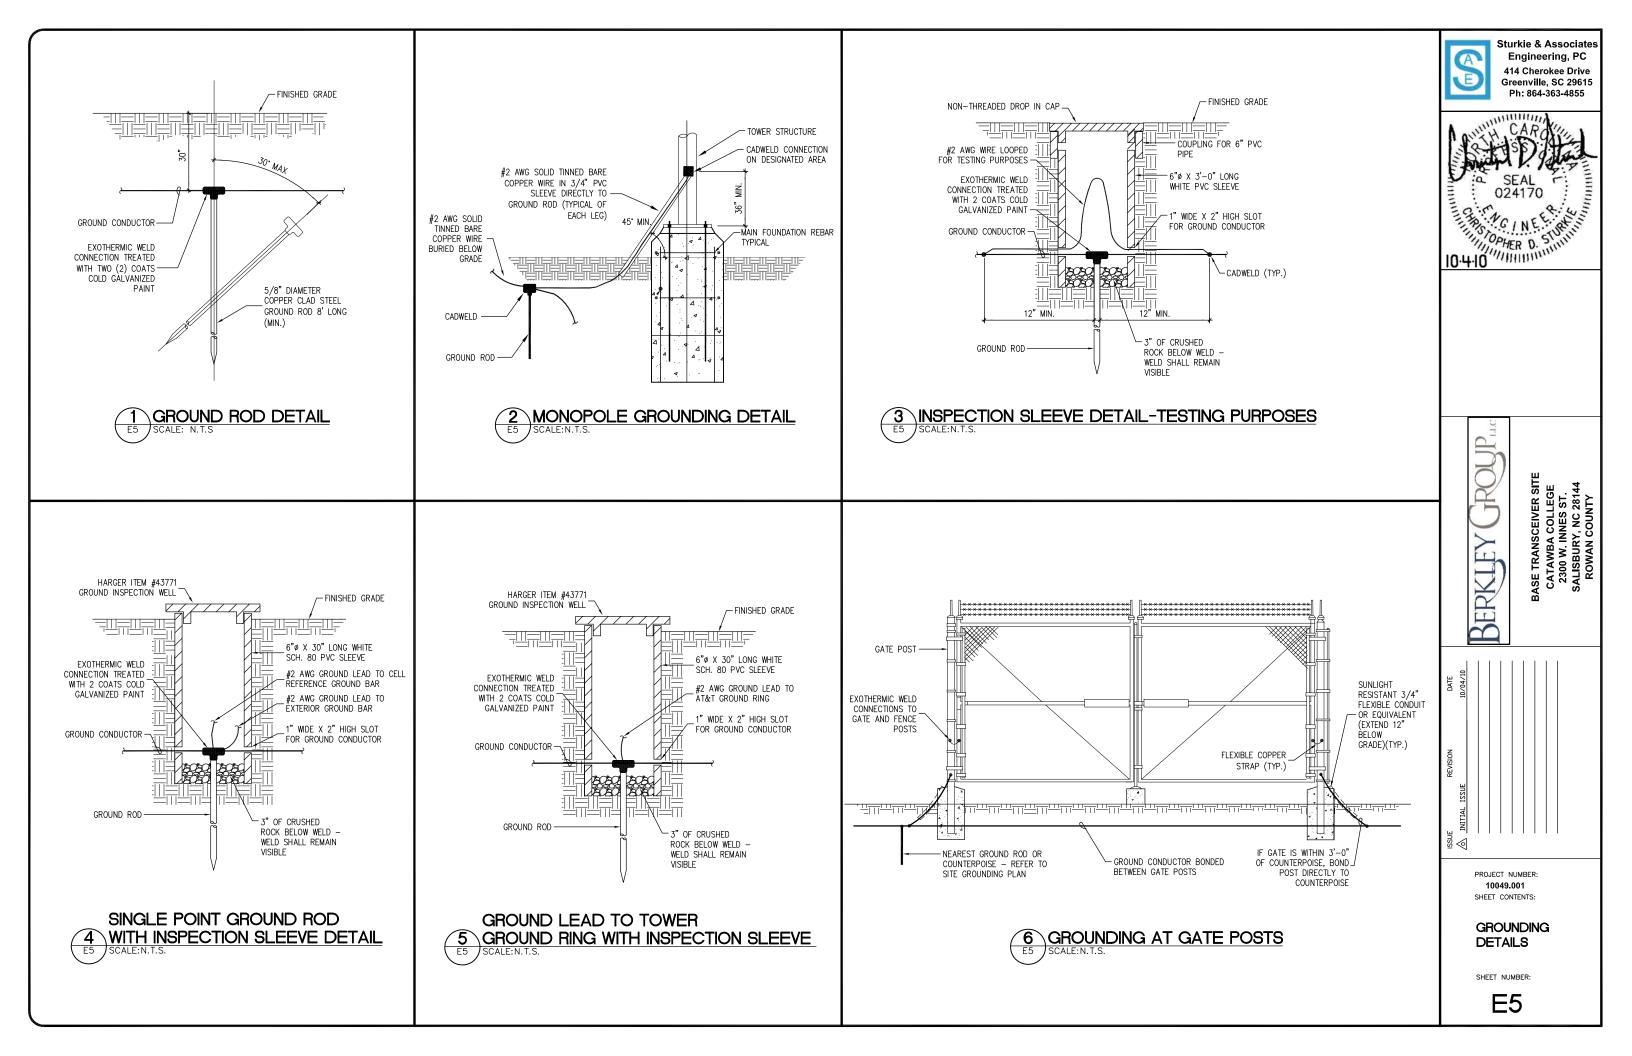

1 TYPICAL ICE BRIDGE/TOWER GROUNDING

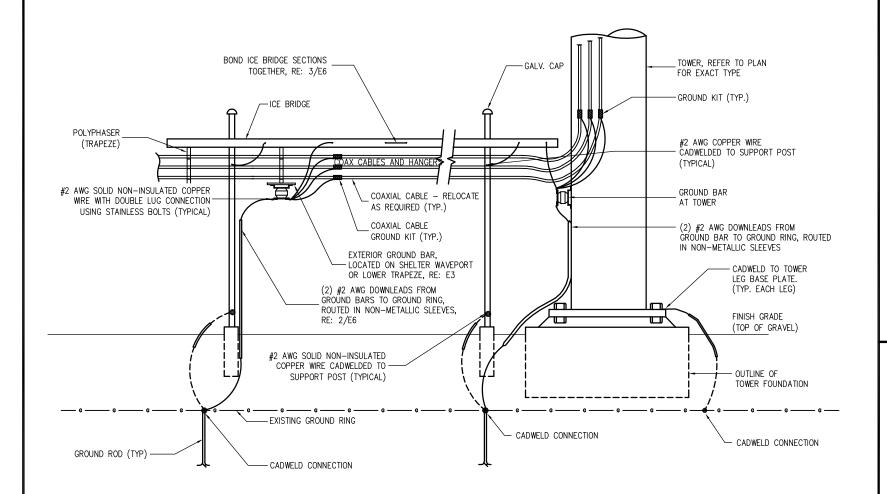
SCALE: N.T.S.




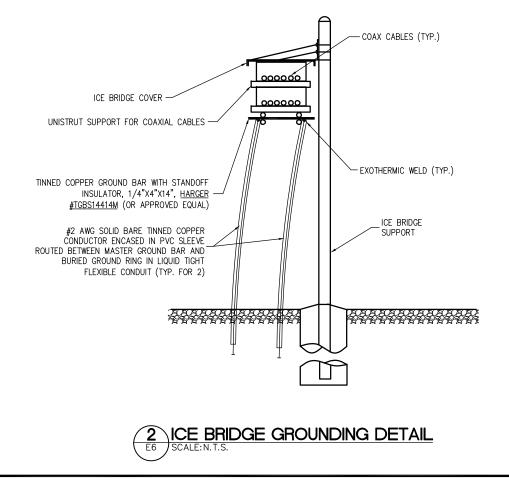


3 ICE BRIDGE SPLICE GROUNDING DETAIL

E6 SCALE: N.T.S.

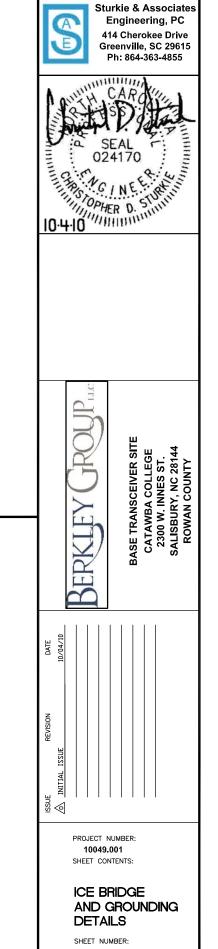

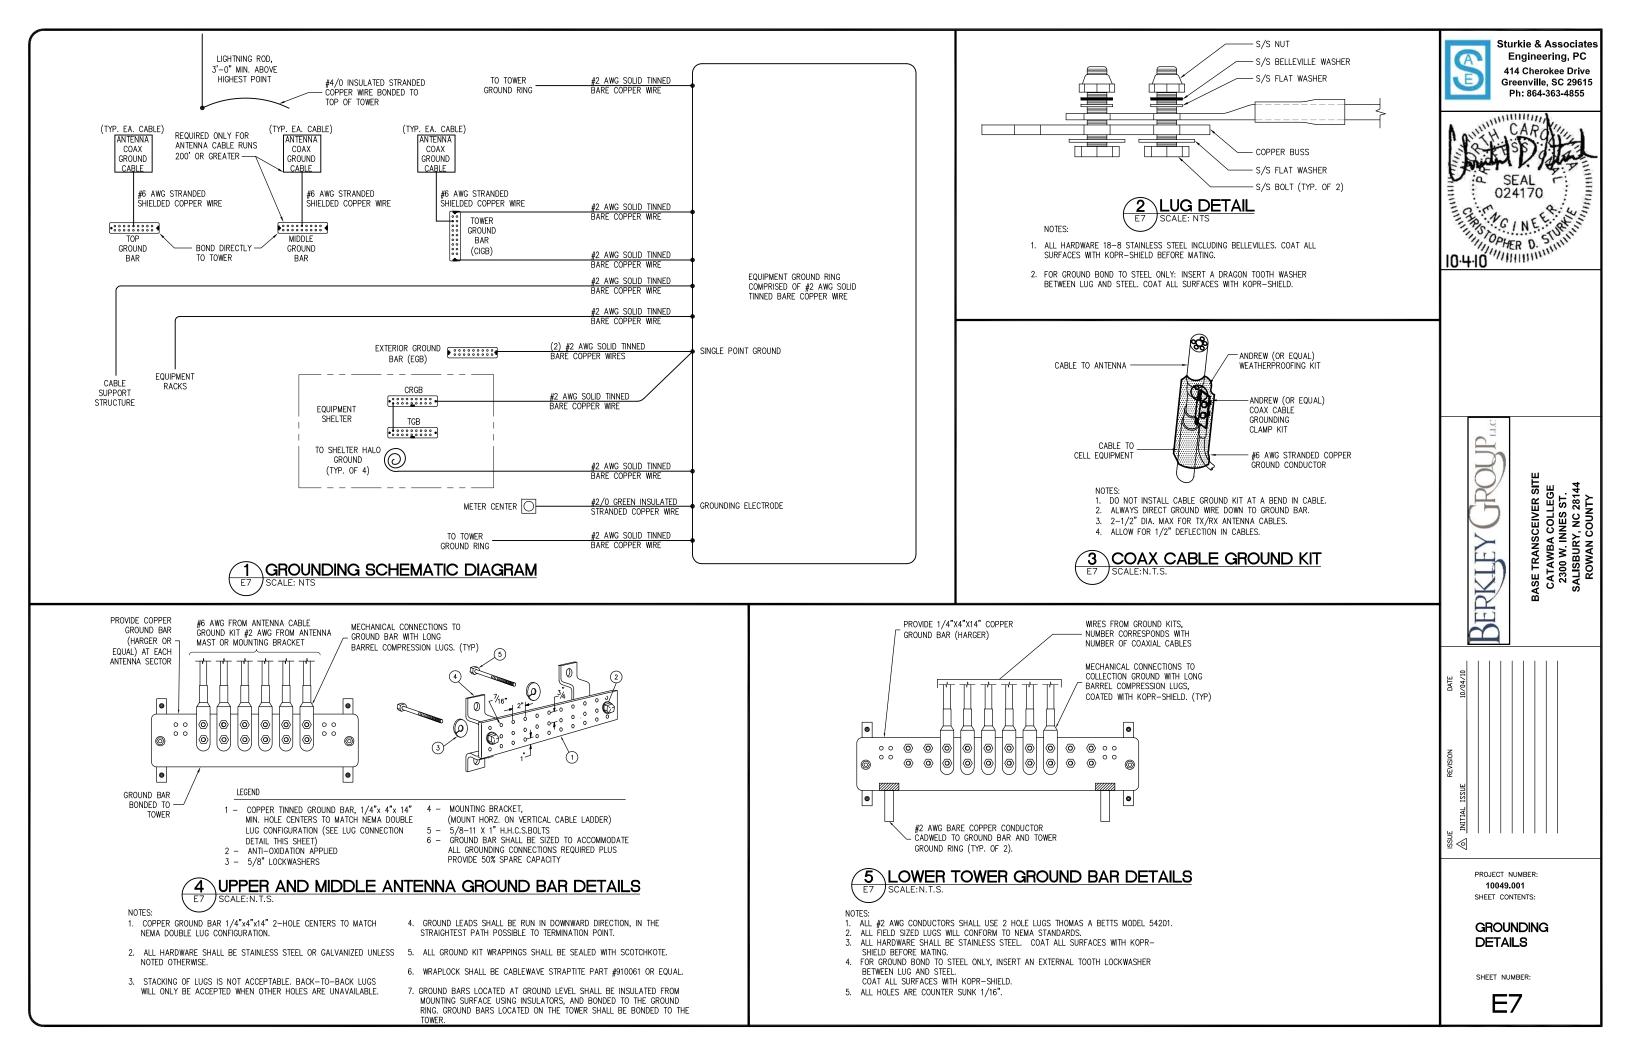

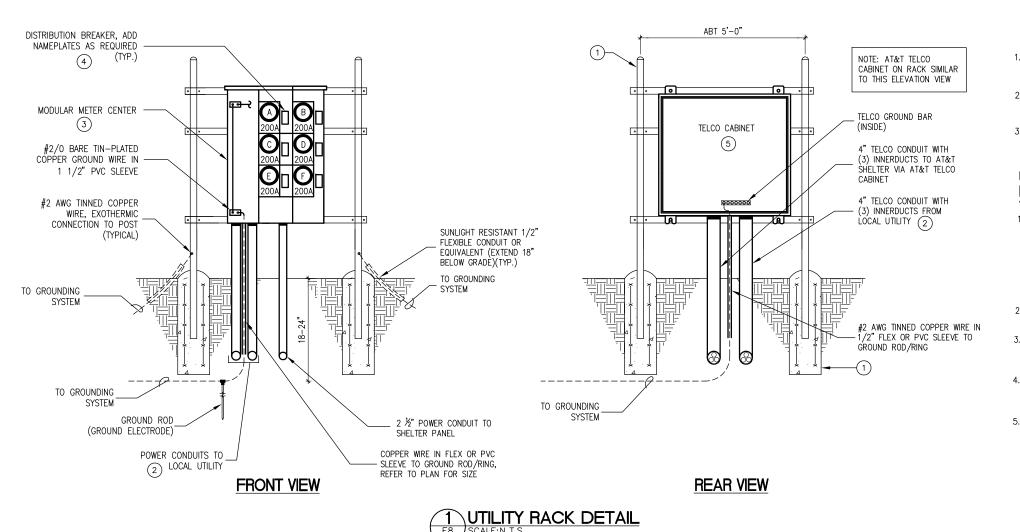

#### **GENERAL NOTES**


- DIMENSIONS SHOWN ARE APPROXIMATE. EXACT DIMENSIONS MAY BE MODIFIED SLIGHTLY BASED ON EXACT EQUIPMENT OBTAINED, SITE CONDITIONS, AND OWNER PREFERENCES.
- 2. POWER EQUIPMENT SHALL BE SQUARE D, SIEMENS, CUTLER HAMMER, OR GENERAL ELECTRIC. ALL EQUIPMENT MUST BE OF ONE
- 3. UNUSED CONDUITS SHALL BE SEALED TO PREVENT MOISTURE INSIDE CONDUITS. USED CONDUITS SHALL BE SEALED AFTER SERVICES HAVE

#### UTILITY RACK NOTES BY SYMBOL "


- 1. EQUIPMENT RACK SHALL BE APPROXIMATELY 5'-0" WIDE AND A MAXIMUM OF 6'-6" HIGH. POSTS SHALL BE 3" GALVANIZED STEEL PIPE WITH CAP. CONTRACTOR SHALL PROVIDE "END CAPS" ON HORIZONTAL UNISTRUT MEMBERS. CROSS MEMBERS SHALL BE UNISTRUT, ANCHORED TO POSTS WITH U-CLAMPS AND 3/8" STAINLESS STEEL BOLTS AND WASHERS. RACK FOUNDATION SHALL BE 1'-0" DIAMETER BY 3'-0" DEEP, CONCRETE REINFORCED WITH
- 2. CONTRACTOR SHALL COORDINATE WITH LOCAL UTILITY COMPANY FOR INSTALLATION OF INCOMING SERVICE CONDUCTORS.
- PROVIDE MODULAR METERING MAIN SERVICE CENTER RATED FOR 120/240V, 600A, SINGLE PHASE, 3 WIRE, 22K AIC (MIN), NEMA 3R, WITH SIX (6) 200A METER SOCKETS.
- 4. CONTRACTOR SHALL PROVIDE AND INSTALL NAMEPLATE ON METER TO INDICATE "AT&T". NAMEPLATES SHALL BE PHENOLIC, WHITE LETTERS
- 5. CONTRACTOR SHALL PROVIDE AND INSTALL TELCO CABINET, 48"Hx48"Wx12"D WITH GROUND BAR. COORDINATE EXACT REQUIREMENTS WITH OWNER/AT&T CONSTRUCTION MANAGER.



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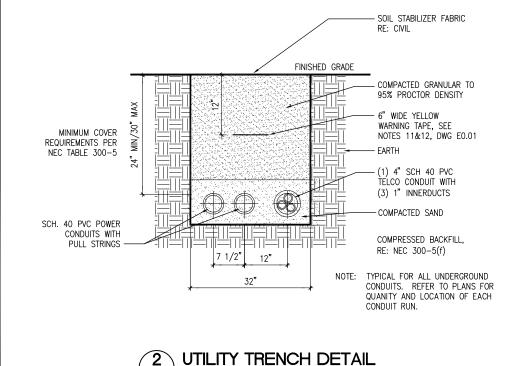


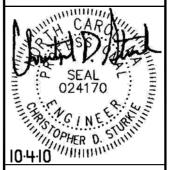
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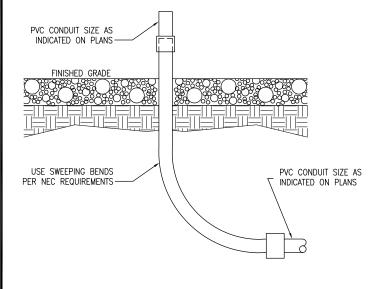
**UTILITY RACK** AND TRENCH DETAILS

SHEET NUMBER:

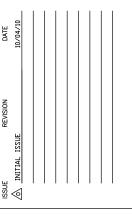E8





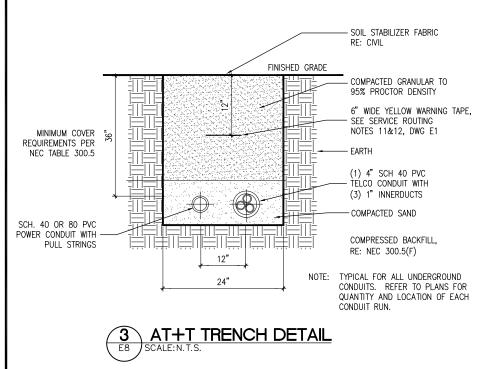

CONDUIT TRANSITION DETAIL